



REPAIR PARKING LOT WEST OF BUILDING U-132

NORFOLK NAVAL STATION NORFOLK, VA

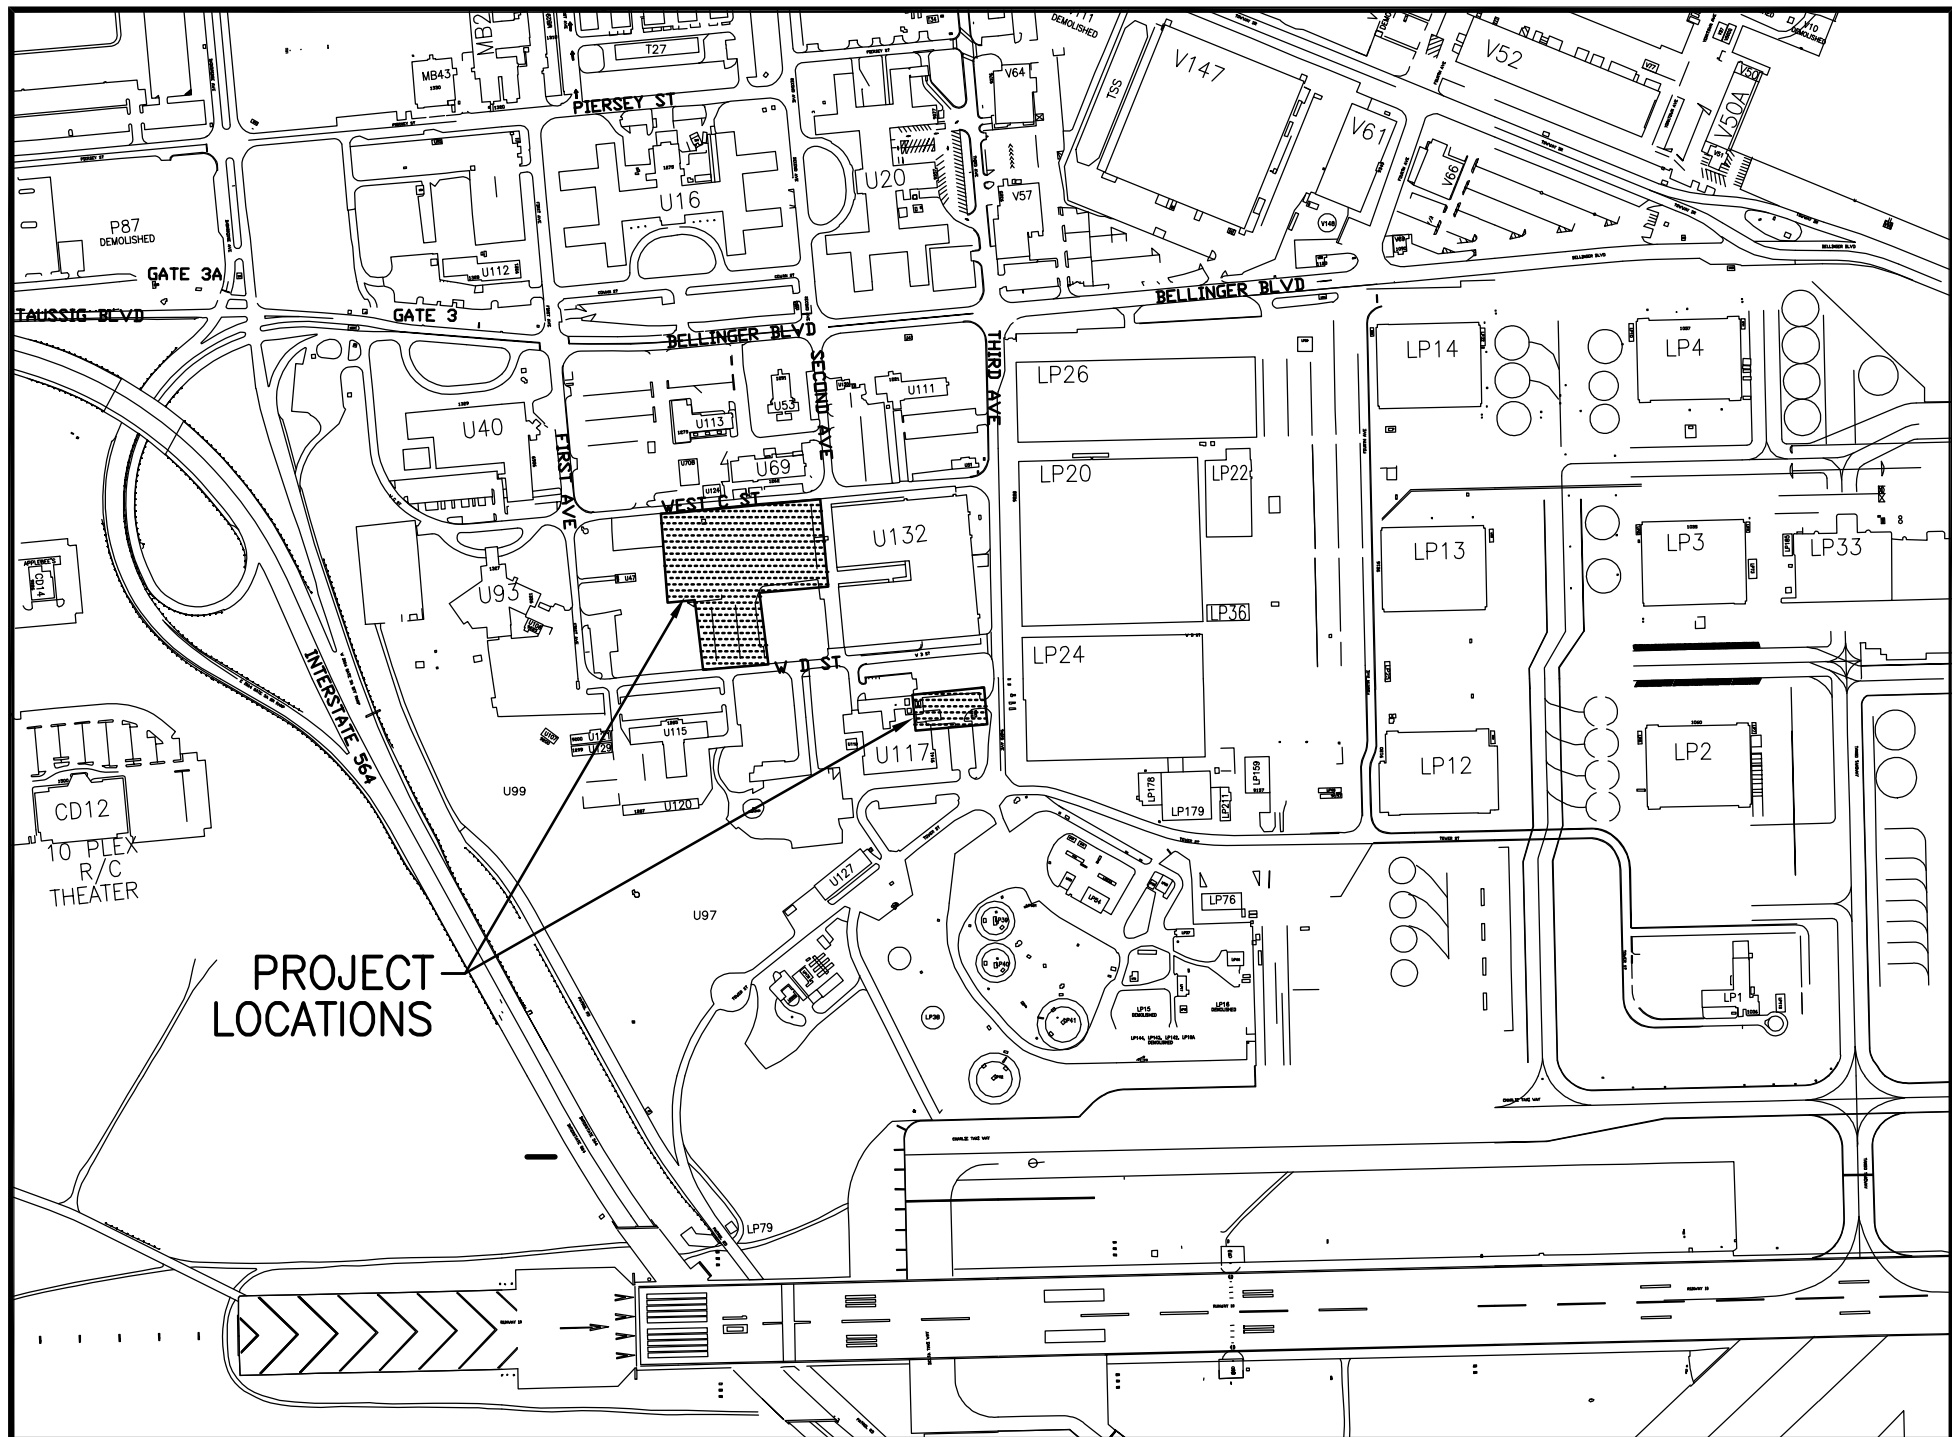

LOCATION MAP

NOT TO SCALE

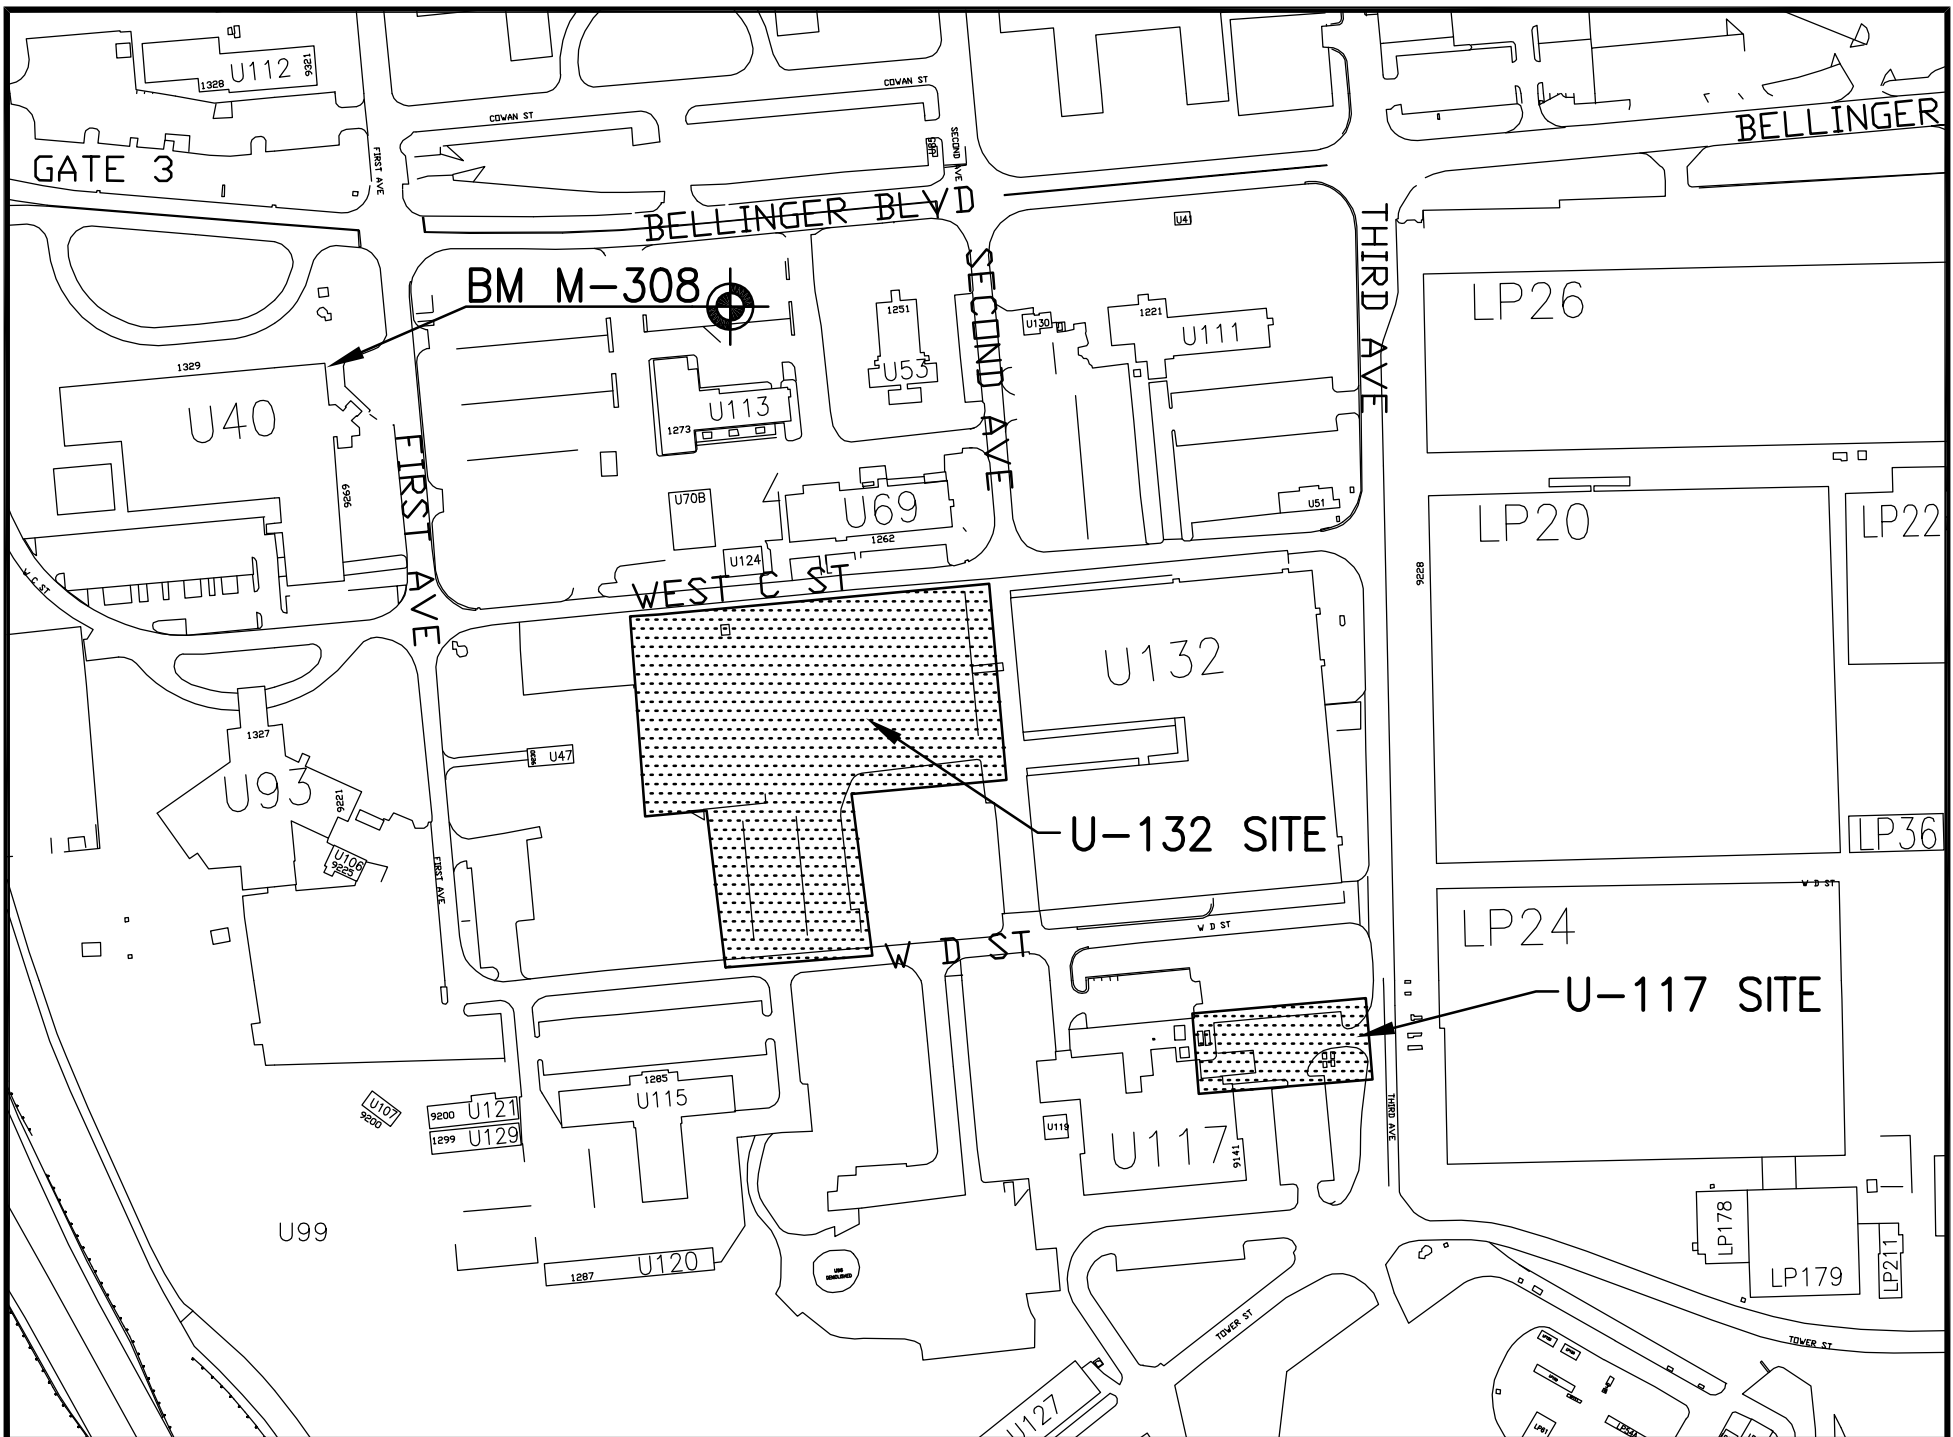

SITE MAP

NOT TO SCALE

INDEX OF DRAWINGS

SHEET NO.	NAVFAC NO.	SHEET TITLE
G-001	4503333	TITLE SHEET
C-001	4503334	GENERAL NOTES, LEGEND AND ABBREVIATIONS
C-101	4503335	TOPOGRAPHIC SURVEY
C-102	4503336	DEMOLITION PLAN - U-132
C-103	4503337	DEMOLITION PLAN - U-117
C-104	4503338	LAYOUT AND UTILITY PLAN - U-132
C-105	4503339	LAYOUT AND UTILITY PLAN - U-117
C-106	4503340	GRADING AND DRAINAGE PLAN - U-132

SHEET NO.	NAVFAC NO.	SHEET TITLE
C-107	4503341	GRADING AND DRAINAGE PLAN - U-117
C-501	4503342	SITE DETAILS
C-502	4503343	SITE DETAILS
C-701	4503344	CONSTRUCTION NOTES
E-001	4503345	LEGEND, DETAILS AND LIGHTING SCHEDULE
E-101	4503346	DEMOLITION PLAN
E-102	4503347	ELECTRICAL LIGHTING PLAN
E-103	4503348	ELECTRICAL LIGHTING PLAN
E-501	4503349	SPECIFICATIONS

DESIGNED & ENGINEERED BY: LANTDIV NAVAL FACILITIES ENGINEERING COMMAND	APPROVED VIA FACSIMILE LCDR BARTOE ACTIVITY - SATISFACTORY TO 24 NOV 2003 DATE APPROVED <i>J. B. Barten</i> FOR EFD FOR COMMANDER NAVFAC 4/17/03 DATE A/E DESIGN DRAWN REVIEW QC CHIEF ARCH/ ENGR. PROJECT MANAGER FIRE PROTECTION BRANCH MANAGER DESIGN DIRECTOR	NAVFAC DRAWING NO. 4503333 SHEET 1 OF 17 G-001
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EXISTING


SPOT ELEVATION 12.00 (TOP OF CURB)
12.00 (TOP OF PVMT.)

APPROX

	R	RADIUS
DI	RD	ROOF DRAIN
	RCR	REINFORCED CONCRETE PIPE


1 TOP

5. PROVIDE TOPSOIL, SEED AND FERTILIZER TO ALL DISTURBED NON-PAVED AREAS WITHIN THE LIMITS OF CONSTRUCTION.

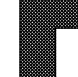

DESIGNED & ENGINEERED BY:
LANTDIV
 NAVAL FACILITIES ENGINEERING COMMAND


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STORM DRAINAGE STRUCTURES

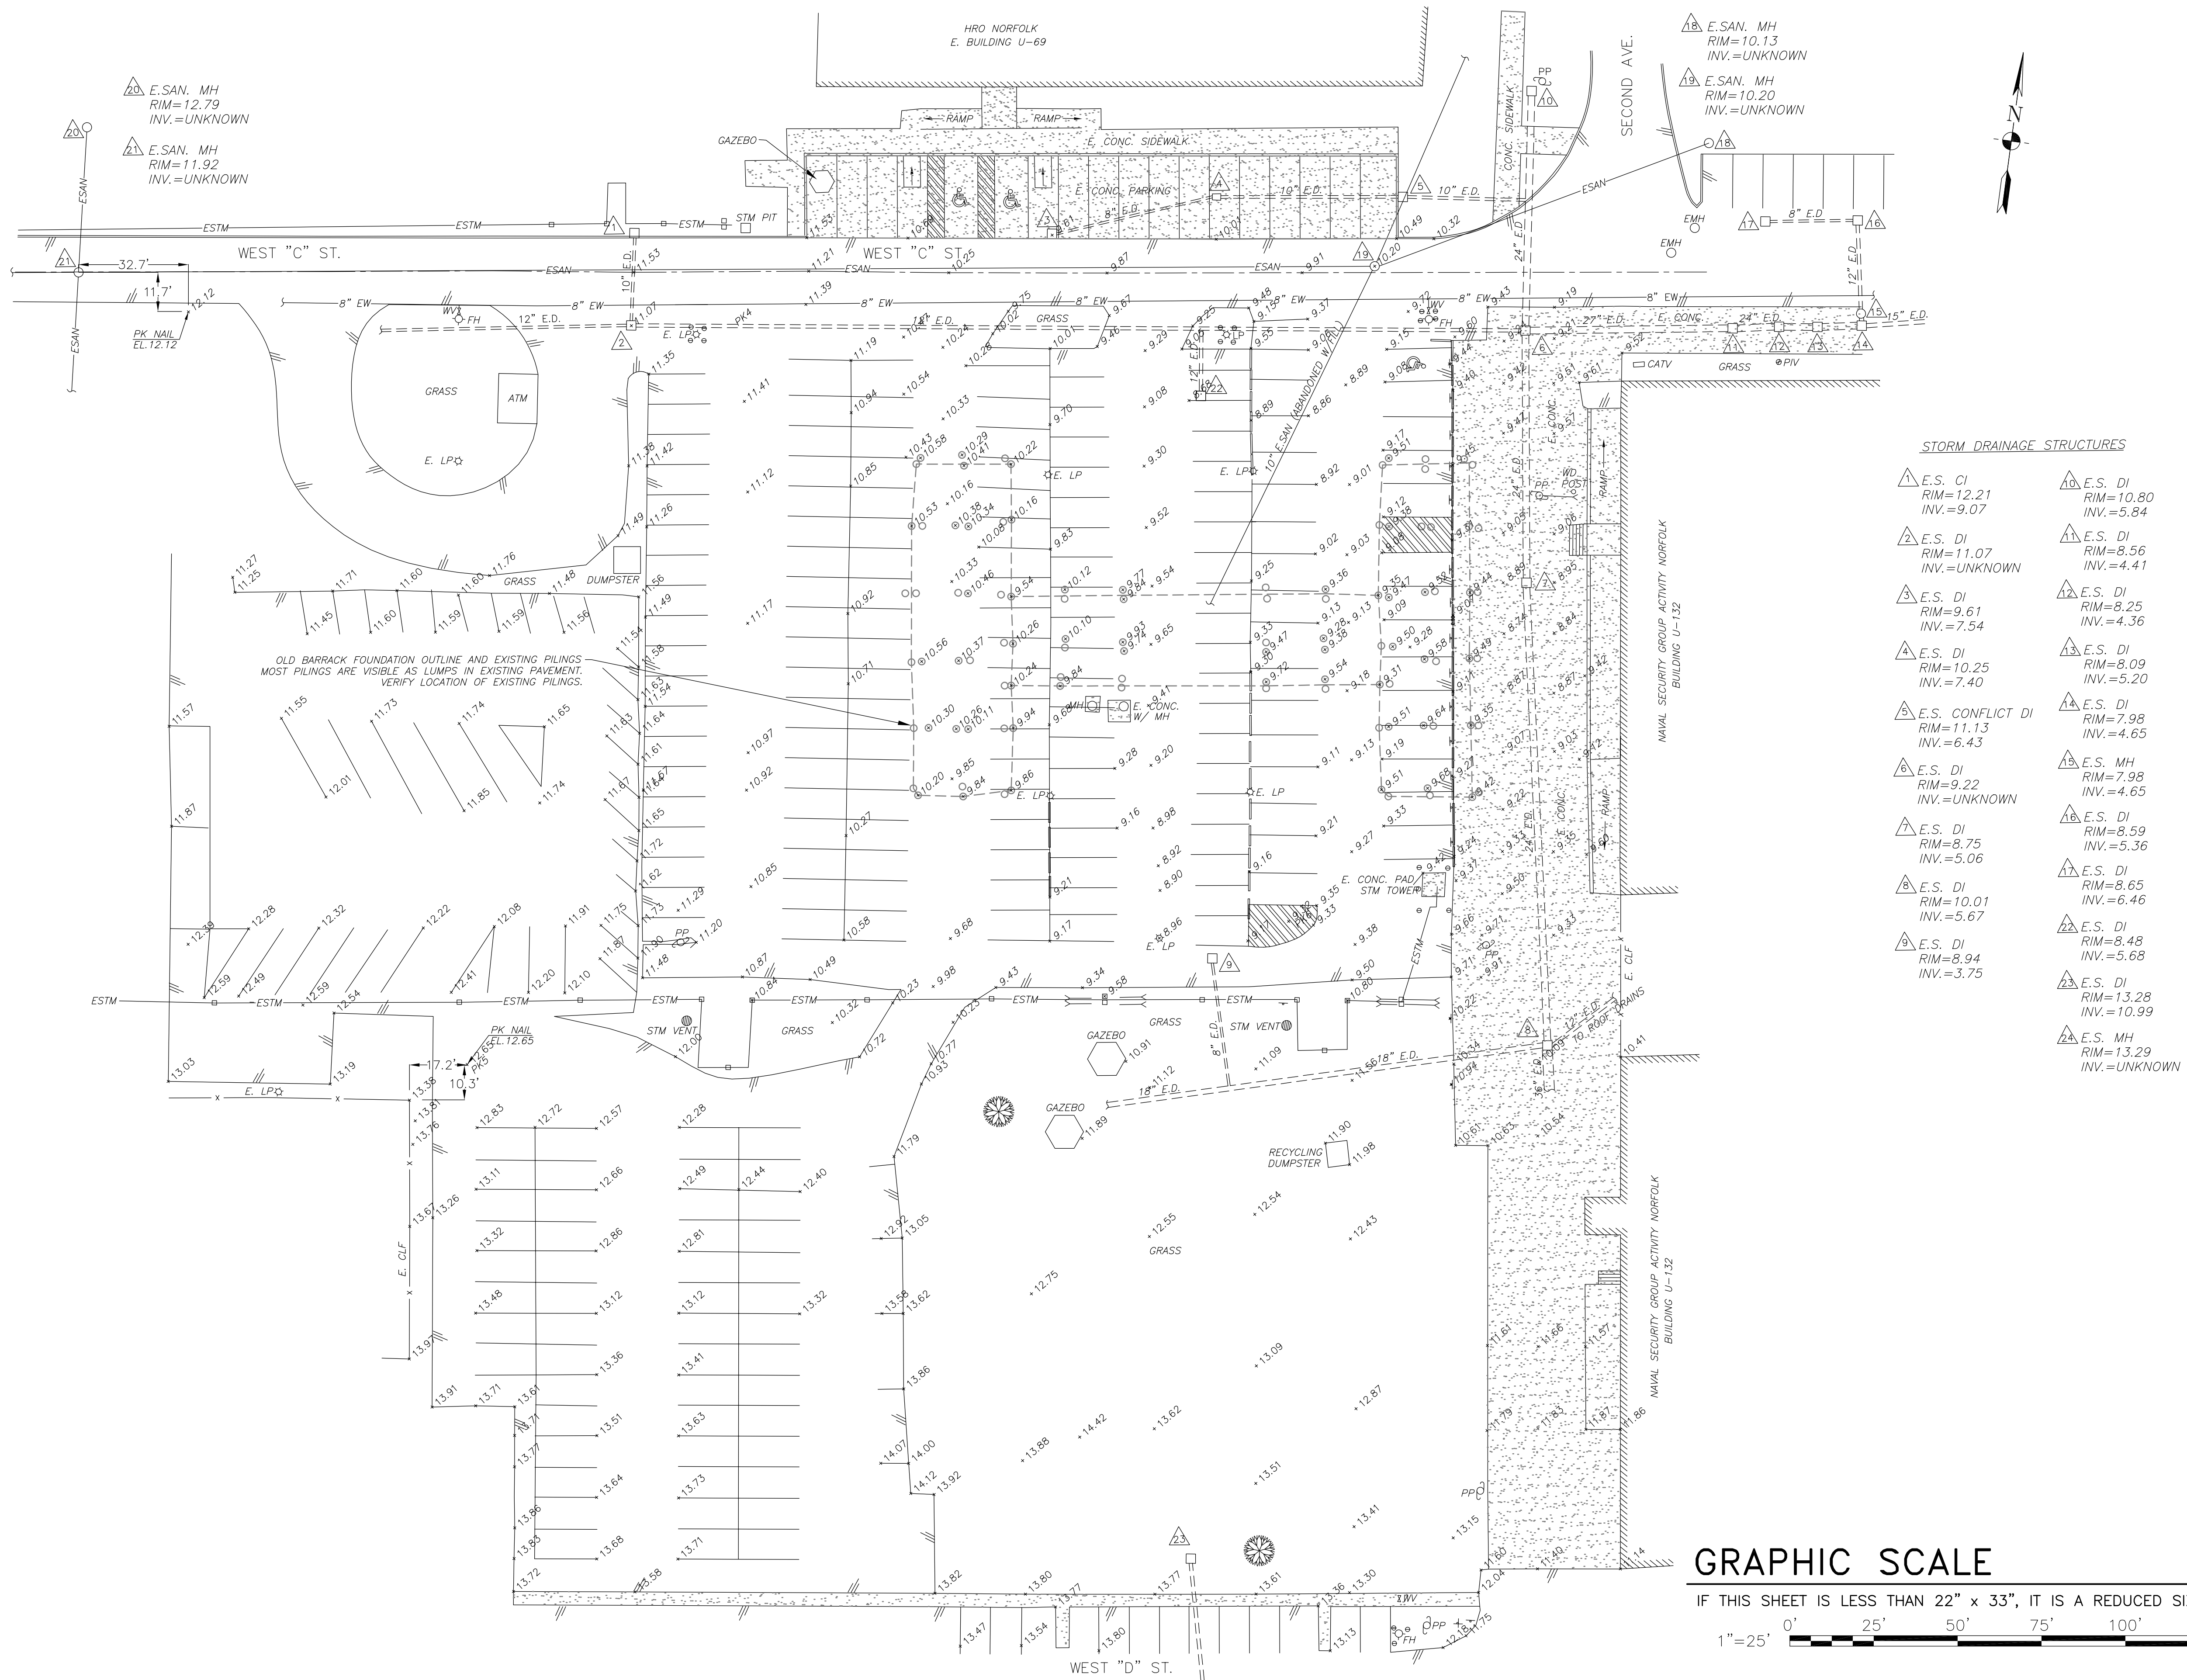1. E.S. CI RIM=12.21 INV.=9.07	10. E.S. DI RIM=10.80 INV.=5.84
2. E.S. DI RIM=11.07 INV.=UNKNOWN	11. E.S. DI RIM=8.56 INV.=4.41
3. E.S. DI RIM=9.61 INV.=7.54	12. E.S. DI RIM=8.25 INV.=4.36
4. E.S. DI RIM=10.25 INV.=7.40	13. E.S. DI RIM=8.09 INV.=5.20
5. E.S. CONFLICT DI RIM=11.13 INV.=6.43	14. E.S. DI RIM=7.98 INV.=4.65
6. E.S. DI RIM=9.22 INV.=UNKNOWN	15. E.S. MH RIM=7.98 INV.=4.65
7. E.S. DI RIM=8.75 INV.=5.06	16. E.S. DI RIM=8.59 INV.=5.36
8. E.S. DI RIM=10.01 INV.=5.67	17. E.S. DI RIM=8.65 INV.=6.46
9. E.S. DI RIM=8.94 INV.=3.75	18. E.S. DI RIM=8.48 INV.=5.68
	19. E.S. DI RIM=13.28 INV.=10.99
	20. E.S. MH RIM=13.29 INV.=UNKNOWN

DESIGNED & ENGINEERED BY: LANTDIV NAVAL FACILITIES ENGINEERING COMMAND	DATE	APPR
APPROVED	ACTIVITY - SATISFACTORY TO	DATE
APPROVED <i>J. Bowen</i> FOR EFD FOR COMMANDER NAVFAC 4/17/03	DATE	APPROVED
A/E	DESIGN	EFD
	DRAWN	JMF
	REVIEW	TAR
	QC	
	CHIEF ARCH/ ENGR.	
PROJECT MANAGER	FIRE PROTECTION	
BRANCH MANAGER	DESIGN DIRECTOR	
NAVAL FACILITIES ENGINEERING COMMAND	ATLANTIC DIVISION	NORFOLK, VIRGINIA
NAVAL STATION	NORFOLK	NORFOLK, VA
REPAIR PARKING LOT WEST OF BUILDING U-132		
TOPOGRAPHIC SURVEY - U-132		
CODE ID. NO. 80091	SIZE	D
SCALE: 1"=25'		
EFD NO.	STA. PROJ. NO.	R308
SPEC. NO.	CONSTR. CONTR. NO.	N62470-03-C-3040
NAVFAC DRAWING NO.	4503335	
SHEET	3	OF 17
C-101		
DRAWING REVISION SEPT 2001		




FILENAME: 033A0460C-103.DWG, UPDATED ON 12/15/03 AT 08:07, XREFS: 033A0460PROJ-INFO, 033A0460BASE

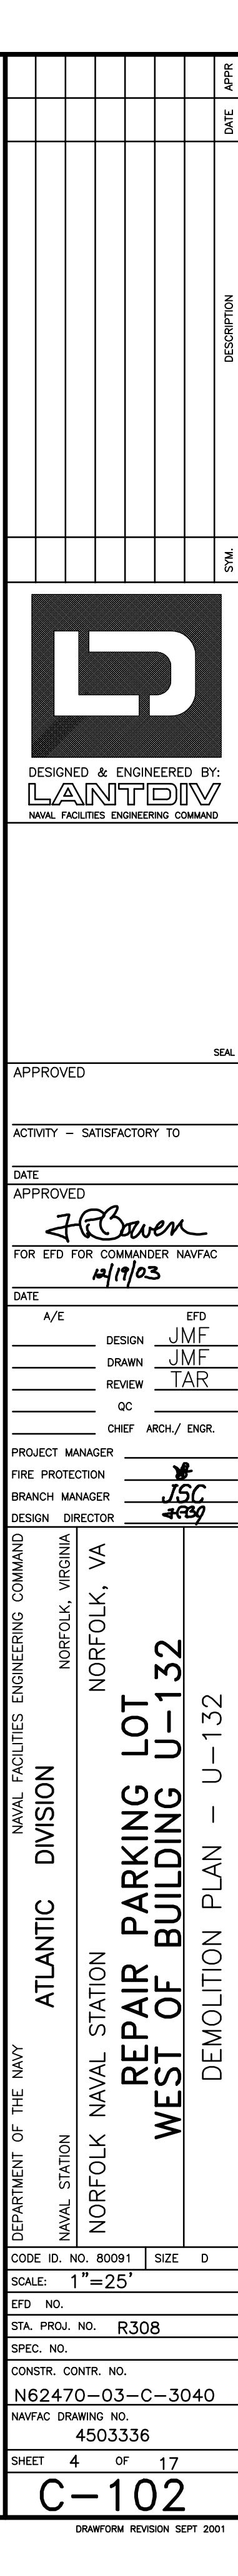DEMOLITION KEY & NOTES

1. REMOVE APPROX. 1,020 SY. OF EXIST. 2" THICK BIT. CONC.
2. REMOVE APPROX. 229 LF. OF EXIST. PCC CURB.
3. REMOVE APPROX 10 EXIST. CONCRETE PILING CAPS (TYP).
(SEE PILING DEMO DETAIL, SHEET C-501)
4. SAWCUT ALL BIT. CONC. AND PCC EDGES FOR REMOVAL.
5. ALL UTILITY STRUCTURES WILL REMAIN AS EXISTING.
6. REFER TO SHEET C-001 FOR GENERAL NOTES, LEGEND AND ABBREVIATIONS.

GRAPHIC SCALE

IF THIS SHEET IS LESS THAN 22" x 33", IT IS A REDUCED SIZE DRAWING

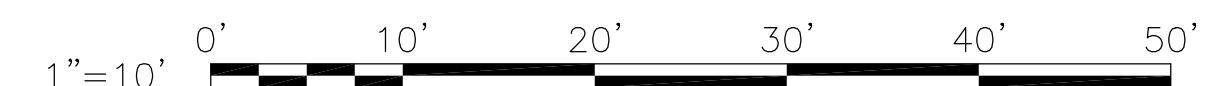


PILINGS ARE VISIBLE AS LUMPS IN EXISTING PAVEMENT.
VERIFY LOCATION OF EXISTING PILINGS.

STORM DRAINAGE STRUCTURES

1 E.S. CI
RIM=12.21
F/L=8.86
INV.=UNKNOWN

2 E.S. CI
RIM=11.07
F/L=8.62
INV.=UNKNOWN

PK NAIL
EL.9.08

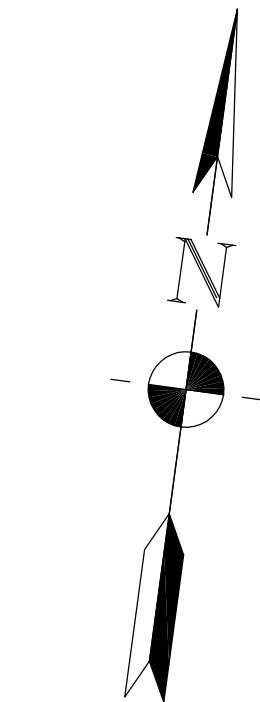

THIRD AVE.

LIMITS OF DEMOLITION

DATE	APPR
DATE	SYM
DESCRIPTION	

DESIGNED & ENGINEERED BY:
LANTDIV
NAVAL FACILITIES ENGINEERING COMMAND

APPROVED	SEAL
ACTIVITY - SATISFACTORY TO	
DATE	
APPROVED	
FOR EFD FOR COMMANDER NAVFAC	
DATE	
A/E	EFD
DESIGN	JMF
DRAWN	JMF
REVIEW	TAR
QC	
CHIEF ARCH/ ENGR.	
PROJECT MANAGER	
FIRE PROTECTION	
BRANCH MANAGER	
DESIGN DIRECTOR	

NAVAL FACILITIES ENGINEERING COMMAND
DIVISION
ATLANTIC
NAVAL STATION
NORFOLK, VIRGINIA
NORFOLK, VA


REPAIR PARKING LOT
WEST OF BUILDING U-132
DEMOLITION PLAN - U-117

CODE ID. NO. 80091	SIZE	D
SCALE: 1"=10'		
EFD NO.		
STA. PROJ. NO. R308		
SPEC. NO.		
CONSTR. CONTR. NO.		
N62470-03-C-3040		
NAVFAC DRAWING NO.		
4503337		
SHEET 5	OF 17	

C-103

DRAWFORM REVISION SEPT 2001

FILENAME: 033A0460C-104.DWG, UPDATED ON 12/15/03 AT 08:07, XREFS: 033A0460PROJ-INFO, 033A0460BASE

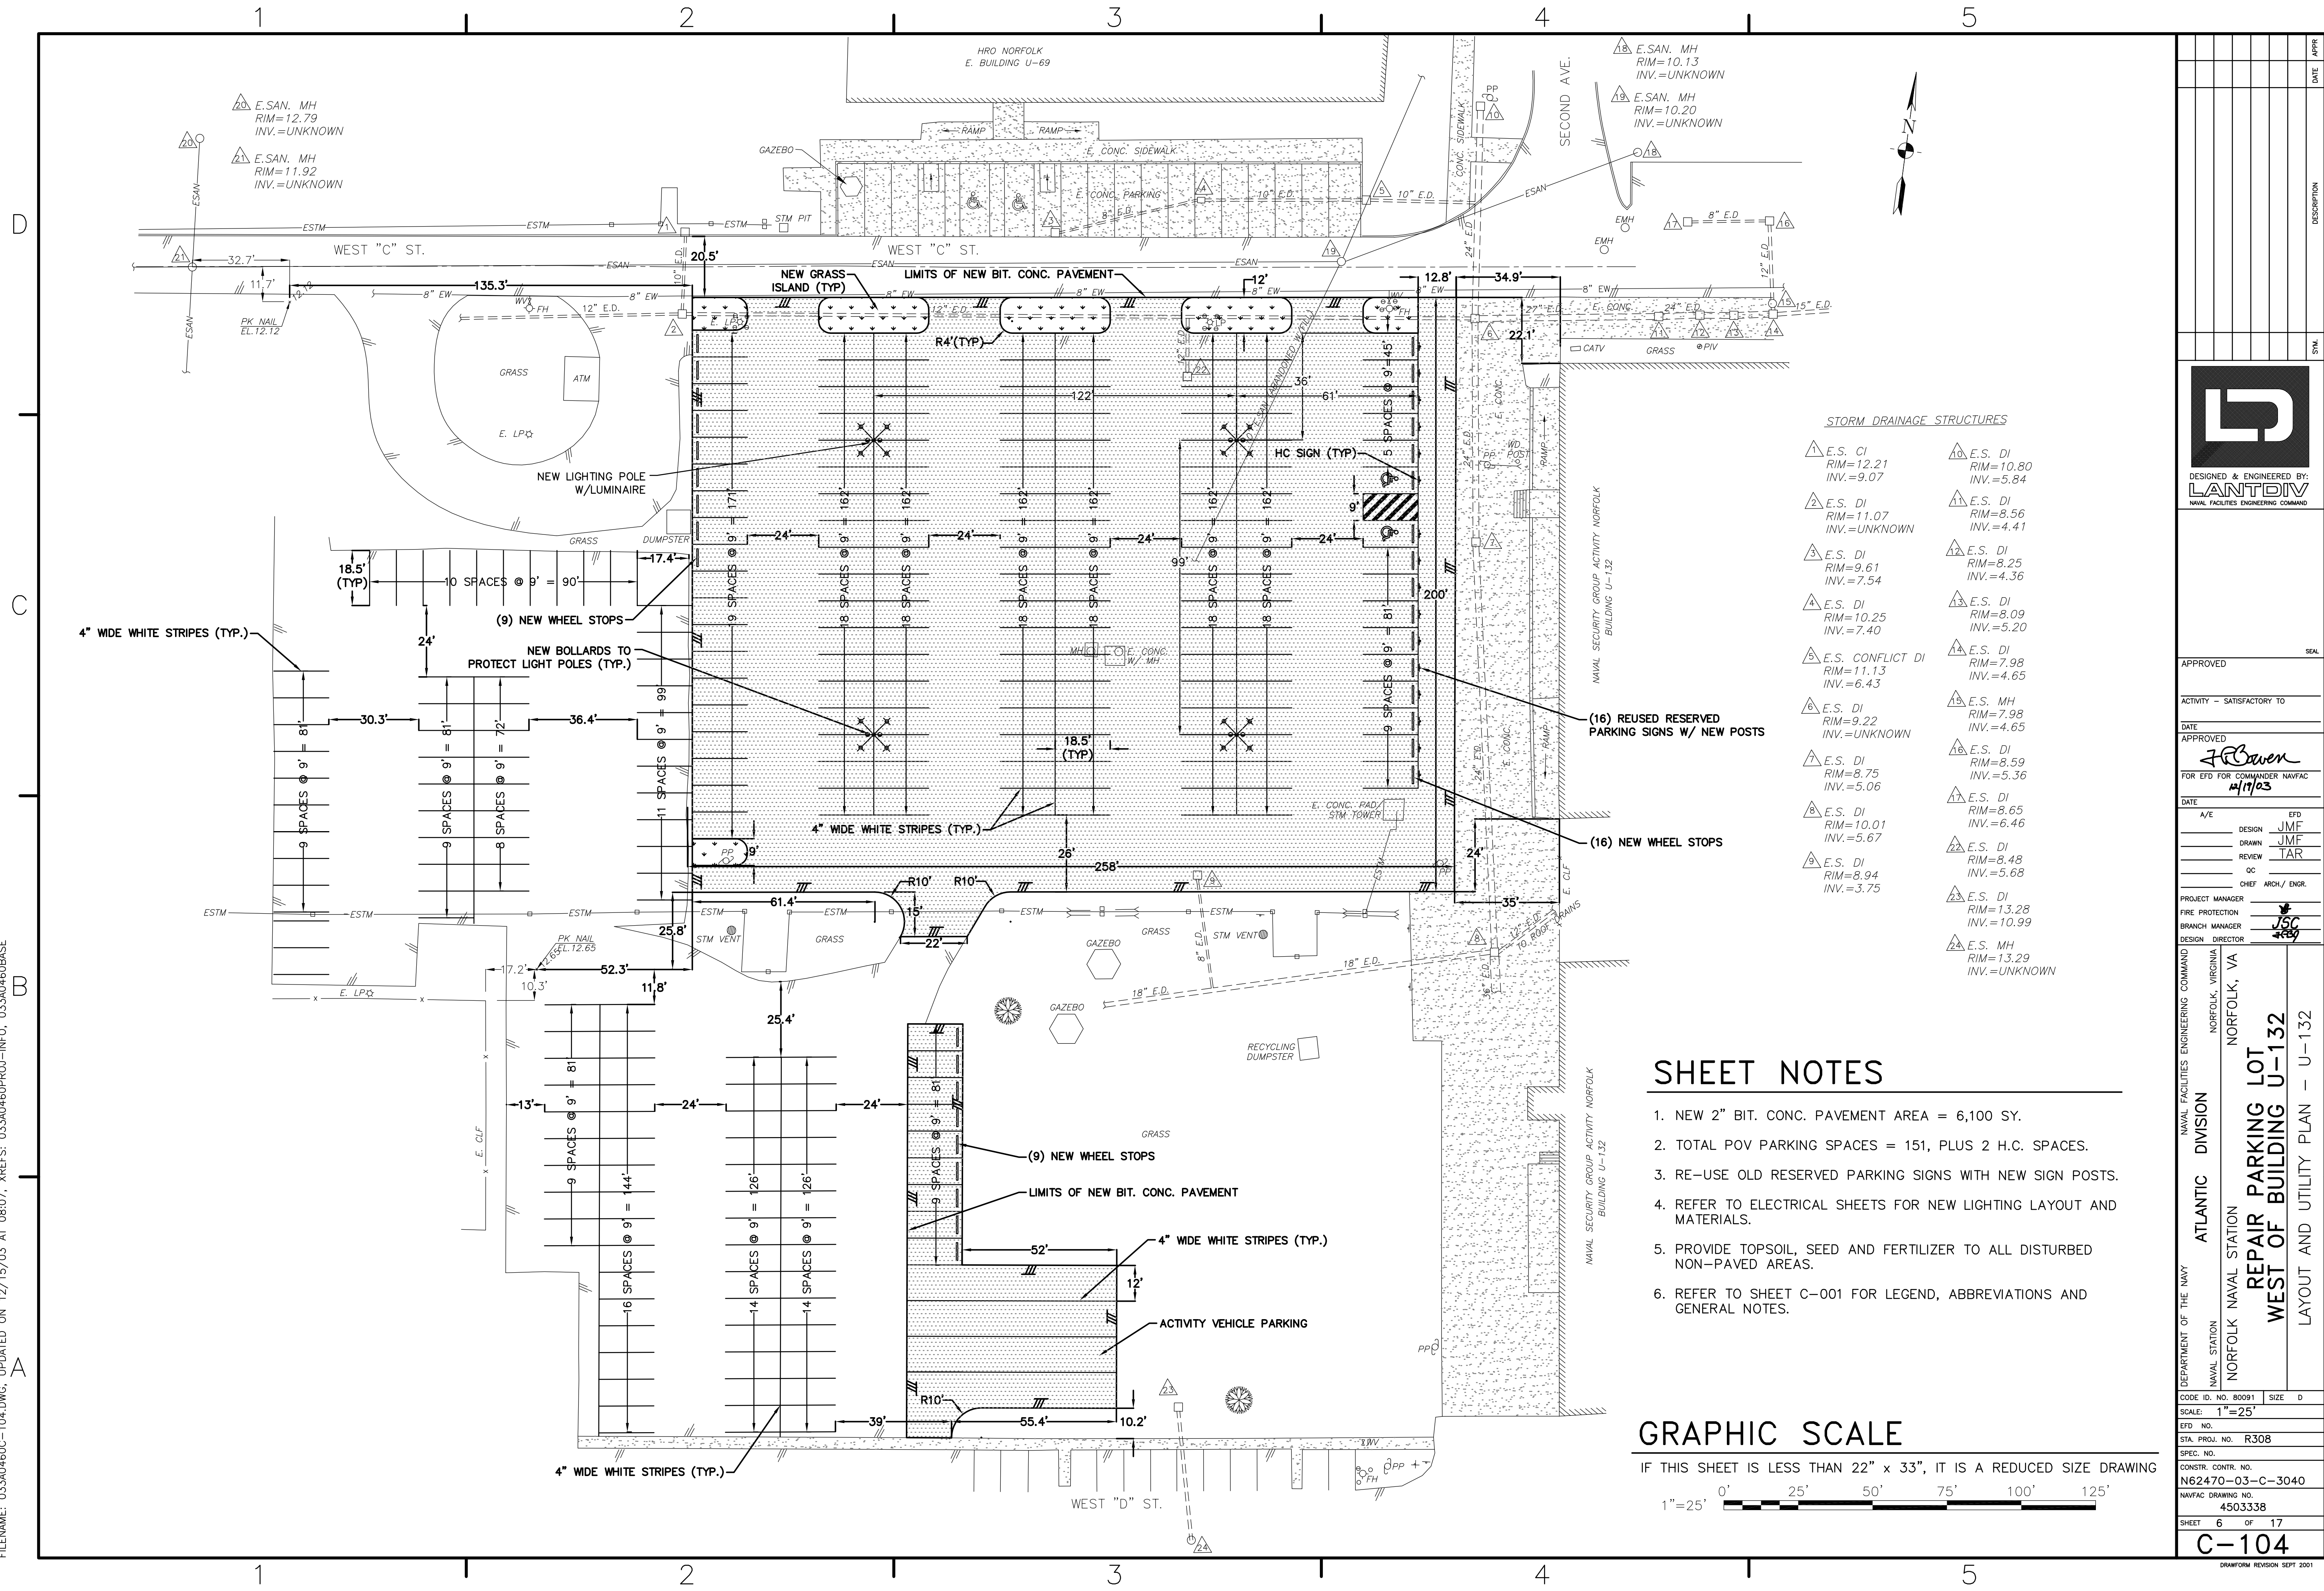


SHEET NOTES

1. NEW 2" BIT. CONC. PAVEMENT AREA = 6,100 SY.
2. TOTAL POV PARKING SPACES = 151, PLUS 2 H.C. SPACES.
3. RE-USE OLD RESERVED PARKING SIGNS WITH NEW SIGN POSTS.
4. REFER TO ELECTRICAL SHEETS FOR NEW LIGHTING LAYOUT AND MATERIALS.
5. PROVIDE TOPSOIL, SEED AND FERTILIZER TO ALL DISTURBED NON-PAVED AREAS.
6. REFER TO SHEET C-001 FOR LEGEND, ABBREVIATIONS AND GENERAL NOTES.

GRAPHIC SCALE

IF THIS SHEET IS LESS THAN 22" x 33", IT IS A REDUCED SIZE DRAWING

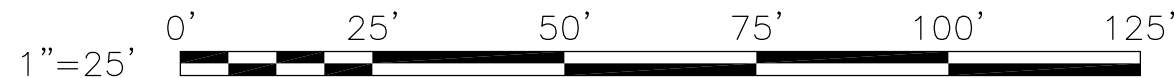

DESIGNED & ENGINEERED BY: LANTDIV NAVAL FACILITIES ENGINEERING COMMAND	DATE: _____ SYN: _____
APPROVED _____ ACTIVITY - SATISFACTORY TO _____ DATE: _____ APPROVED <i>JF Baven</i> FOR EFD FOR COMMANDER NAVFAC 4/17/03	
DATE: _____ A/E: _____ EFD: _____ DESIGN: JMF DRAWN: JMF REVIEW: TAR QC: _____ CHIEF ARCH/ ENGR: _____	
PROJECT MANAGER: _____ FIRE PROTECTION: _____ BRANCH MANAGER: _____ DESIGN DIRECTOR: _____	
NAVAL FACILITIES ENGINEERING COMMAND DIVISION ATLANTIC NAVAL STATION NORFOLK, VIRGINIA NORFOLK, VA	
REPAIR PARKING LOT WEST OF BUILDING U-132 LAYOUT AND UTILITY PLAN - U-132	
CODE ID. NO. 80091 SIZE D SCALE: 1"=25' EFD NO. _____ STA. PROJ. NO. R308 SPEC. NO. _____ CONSTR. CONTR. NO. N62470-03-C-3040 NAVFAC DRAWING NO. 4503338 SHEET 6 OF 17 C-104 DRAWING REVISION SEPT 2001	


FILENAME: 033A0460C-105.DWG, UPDATED ON 12/18/03 AT 13:12, XREFS: 033A0460PROJ-INFO, 033A0460BASE

SHEET NOTES

1. NEW 2" BIT. CONC. PAVEMENT AREA = 997 SY.
2. PROVIDE 4" OF TOPSOIL, SEED AND FERTILIZER TO ALL DISTURBED NON-PAVED AREAS.
3. REFER TO SHEET C-001 FOR LEGEND, ABBREVIATIONS AND GENERAL NOTES.

GRAPHIC SCALE


IF THIS SHEET IS LESS THAN 22" x 33", IT IS A REDUCED SIZE DRAWING

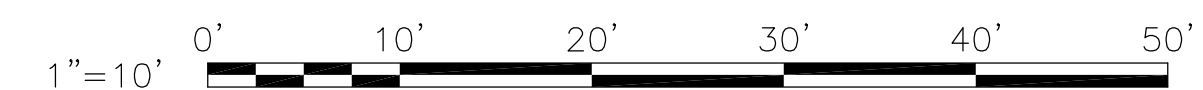

STORM DRAINAGE STRUCTURES

1 E.S. CI
RIM=12.21
F/L=8.86
INV.=UNKNOWN

2 E.S. CI
RIM=11.07
F/L=8.62
INV.=UNKNOWN

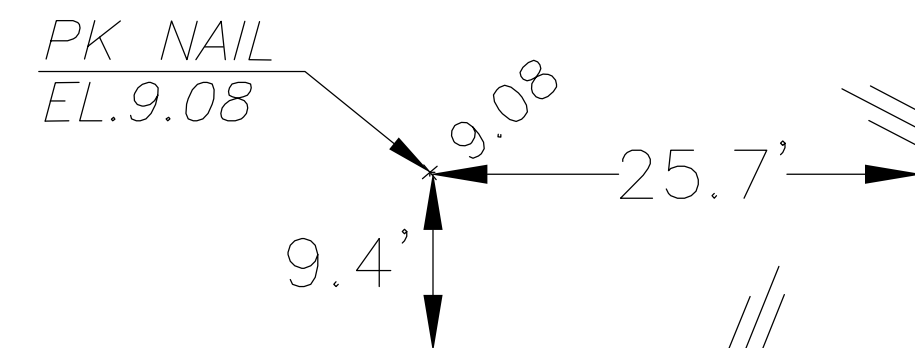

4" WIDE WHITE STRIPES (TYP.)

18.5'

16 SPACES @ 9' = 144'

NEW 140LF-PCC CURB & GUTTER

NEW 53LF-PCC CURB

R6'

NEW 36LF-PCC CURB

36'


PROVIDE WOOD SHEETING
(SEE DETAIL C-502)

BUILDING U-117

STM VENT

E. EMH

THIRD AVE.

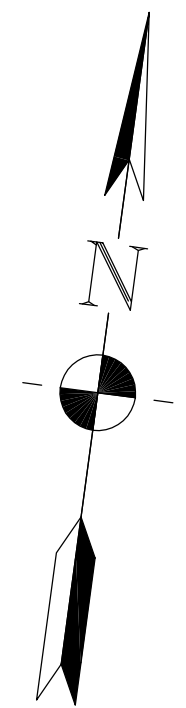

DATE	APPR
DATE	SYM
DESCRIPTION	

DESIGNED & ENGINEERED BY:
LANTDIV
NAVAL FACILITIES ENGINEERING COMMAND

APPROVED	SEAL
ACTIVITY - SATISFACTORY TO	
DATE	
APPROVED	
FOR EFD FOR COMMANDER NAVFAC	
DATE	
A/E	EFD
DESIGN	JMF
DRAWN	JMF
REVIEW	TAR
QC	
CHIEF	ARCH/ ENGR.
PROJECT MANAGER	
FIRE PROTECTION	JSC
BRANCH MANAGER	
DESIGN DIRECTOR	

NAVAL FACILITIES ENGINEERING COMMAND

ATLANTIC DIVISION

NAVAL STATION

NORFOLK, VIRGINIA

NORFOLK, VA

REPAIR PARKING LOT


WEST OF BUILDING U-132

LAYOUT AND UTILITY PLAN - U-117

CODE ID. NO. 80091	SIZE	D
SCALE: 1"=10'		
EFD NO.		
STA. PROJ. NO. R308		
SPEC. NO.		
CONSTR. CONTR. NO.		
NAVFAC DRAWING NO.		
4503339		
SHEET 7	OF 17	

C-105


DRAWN/REVISION SEPT 2001

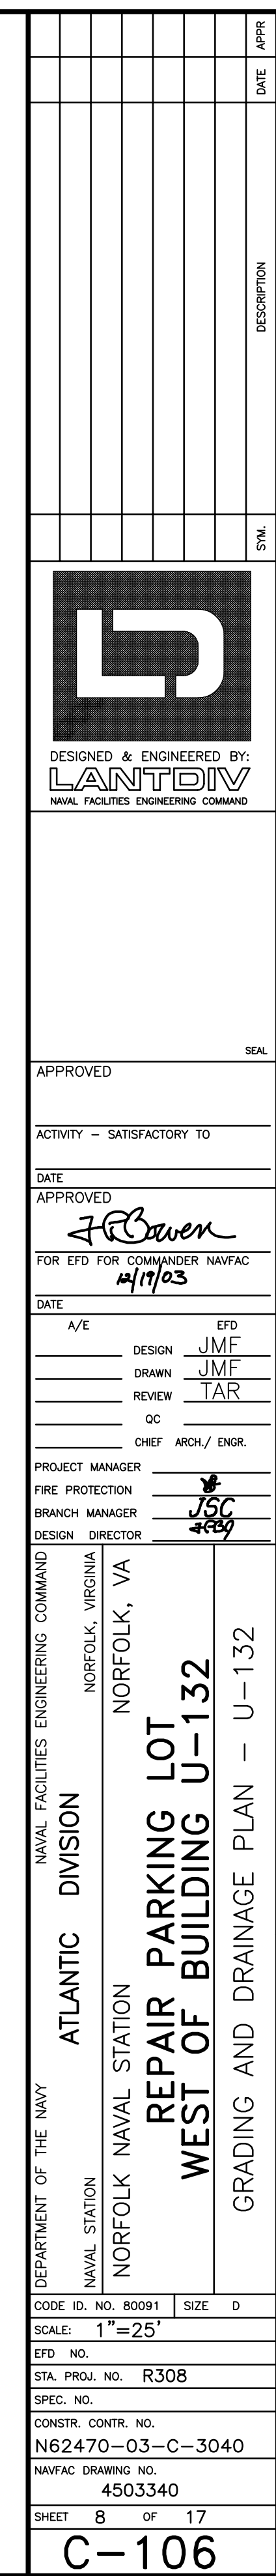

1. ALL GRADE TRANSITIONS BETWEEN NEW AND EXISTING SHALL BE SMOOTH AND GRADUAL WITH NO SHARP OR ABRUPT CHANGES.
2. MATCH RIM ELEVATIONS AT EXISTING DROP INLETS AND OTHER UTILITY STRUCTURES.
3. FILL AREAS WHERE PILINGS TOPS WERE REMOVED WITH SUITABLE FILL MATERIAL. (SEE PILING REMOVAL AND REPAIR DETAIL, SHEET C-501)


IF THIS SHEET IS LESS THAN 22" x 33", IT IS A REDUCED SIZE DRAWING




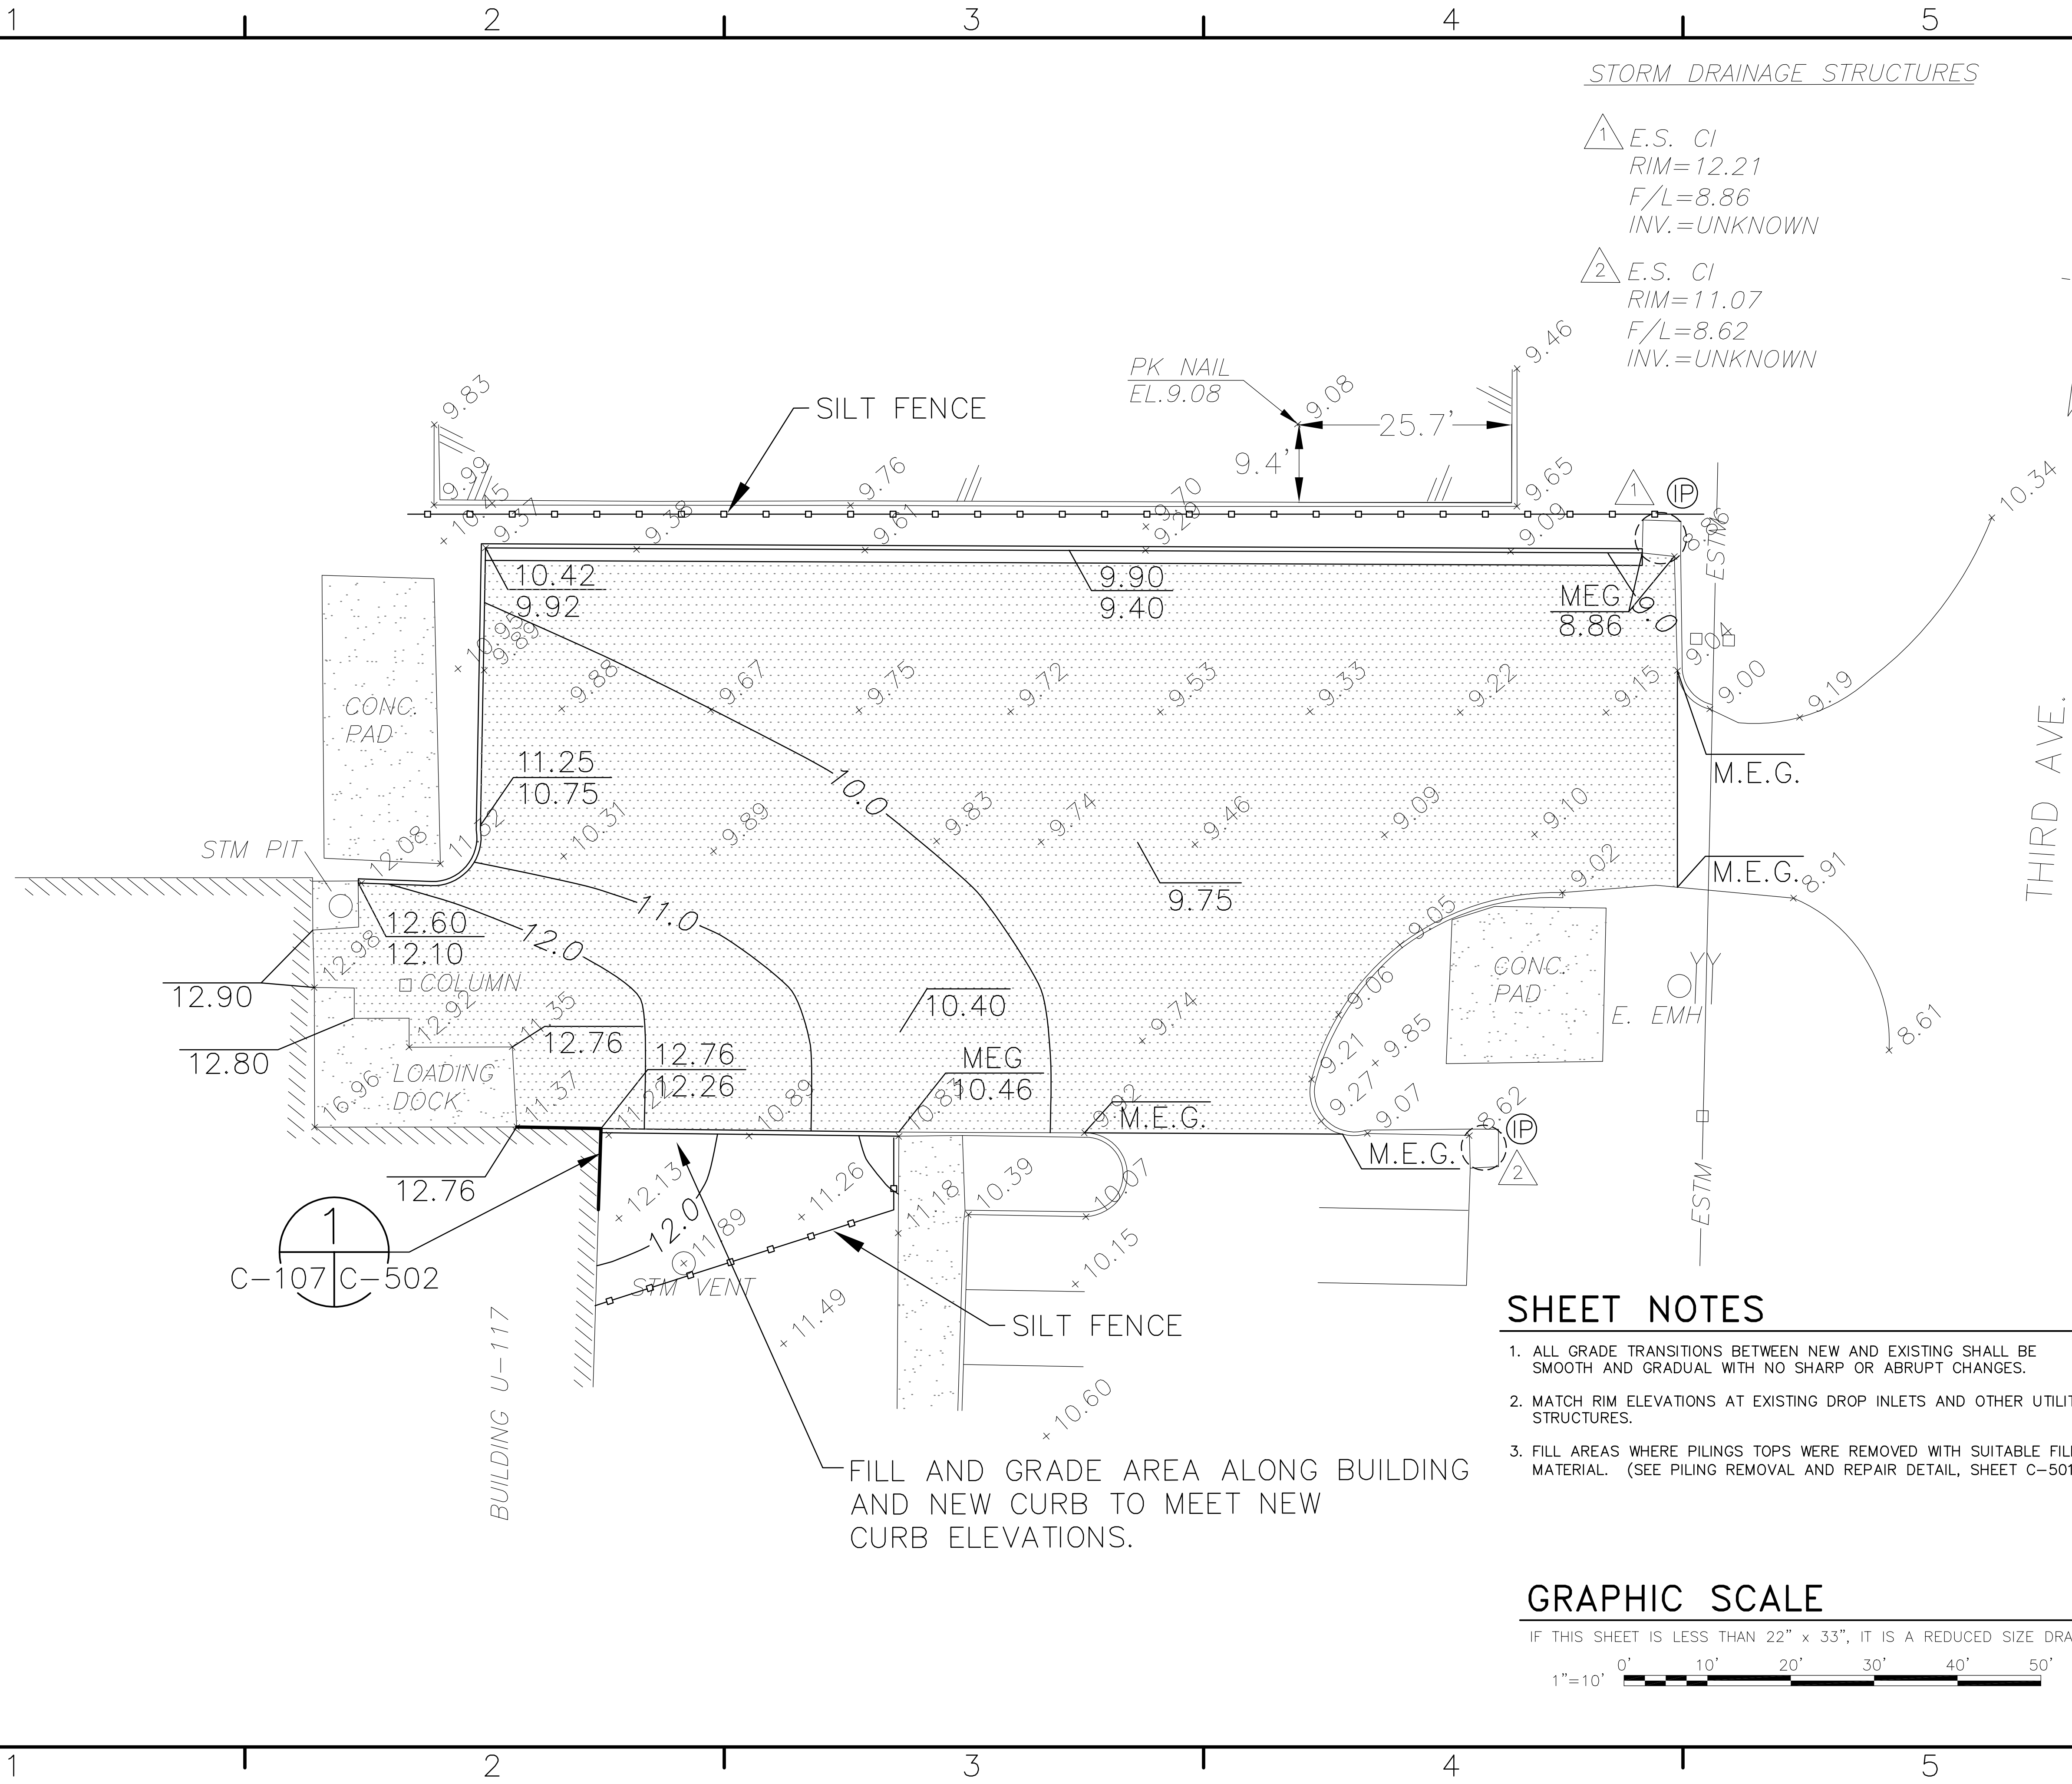

1. ALL GRADE TRANSITIONS BETWEEN NEW AND EXISTING SHALL BE SMOOTH AND GRADUAL WITH NO SHARP OR ABRUPT CHANGES.
2. MATCH RIM ELEVATIONS AT EXISTING DROP INLETS AND OTHER UTILITY STRUCTURES.
3. FILL AREAS WHERE PILINGS TOPS WERE REMOVED WITH SUITABLE FILL MATERIAL. (SEE PILING REMOVAL AND REPAIR DETAIL, SHEET C-501)

IF THIS SHEET IS LESS THAN 22" x 33", IT IS A REDUCED SIZE DRAWING

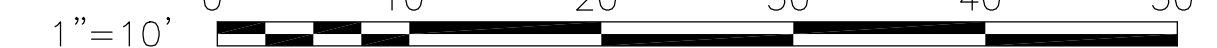[illegible]

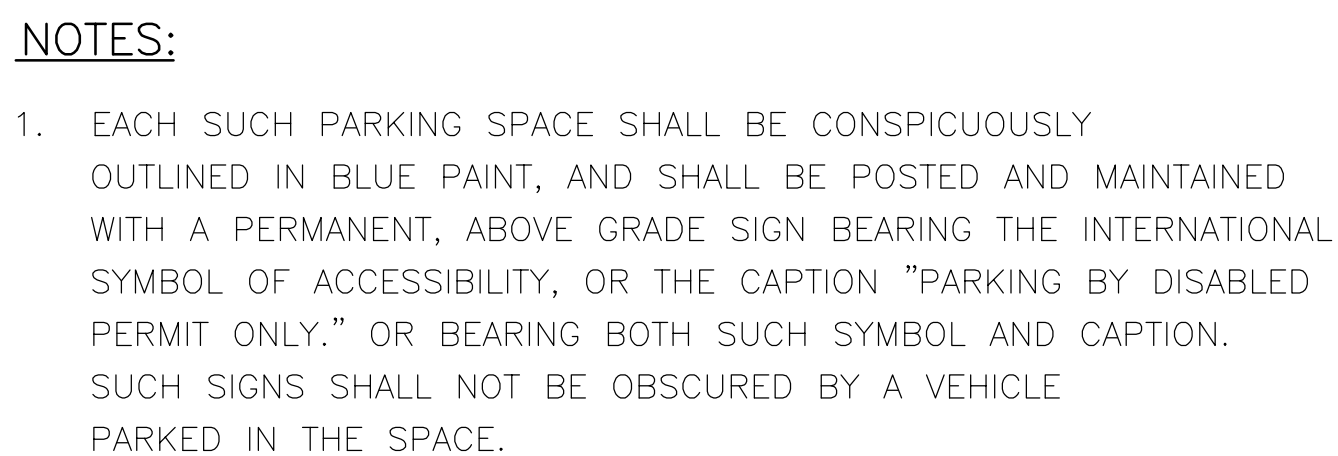

WHITE

4"



24"

4"

45°





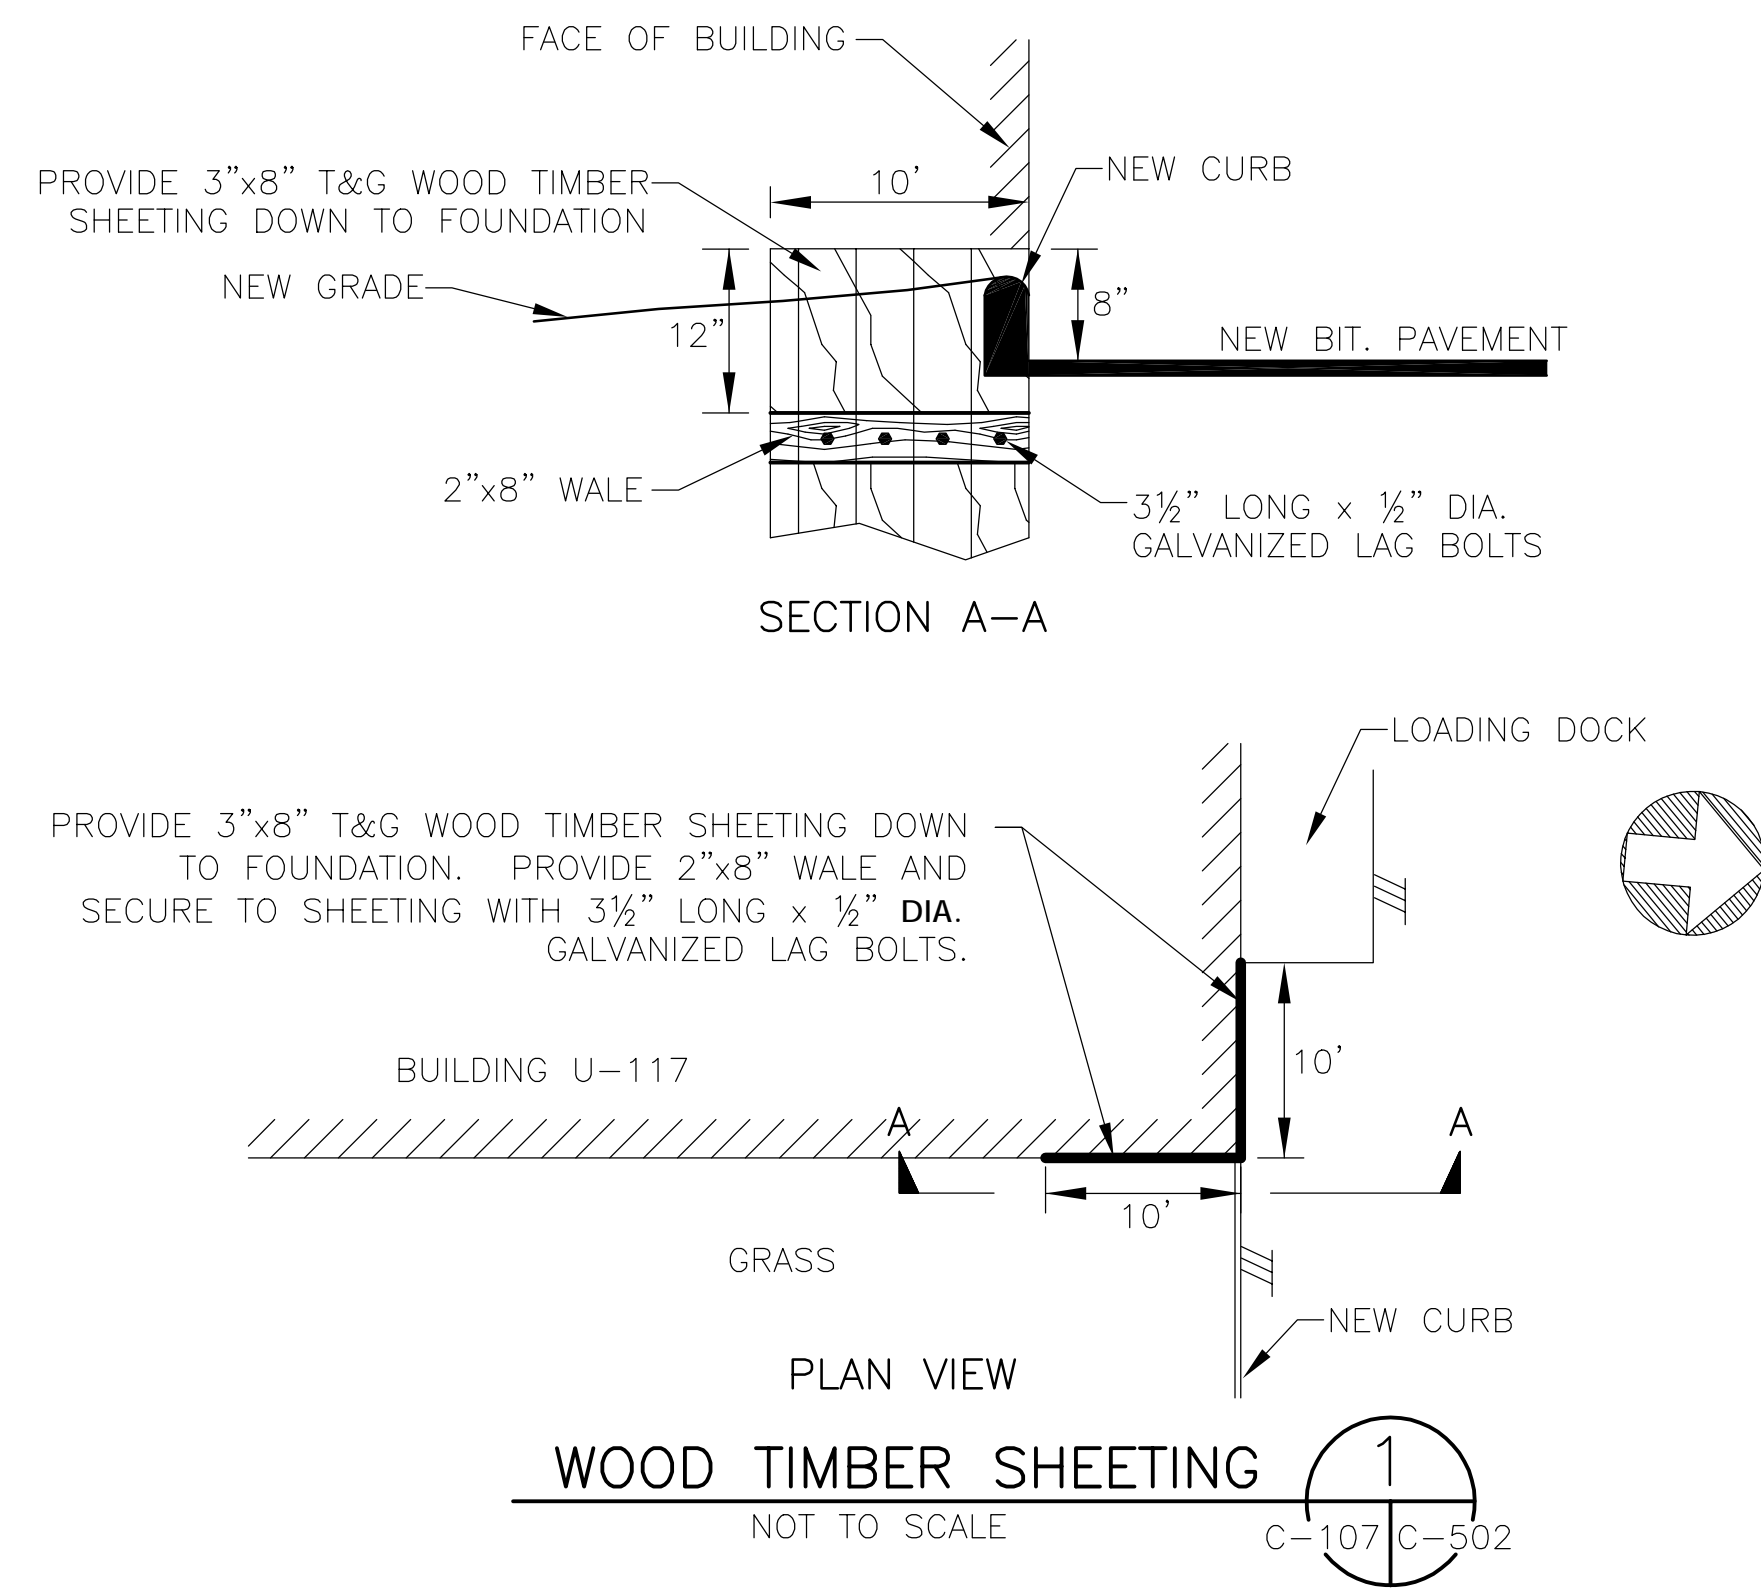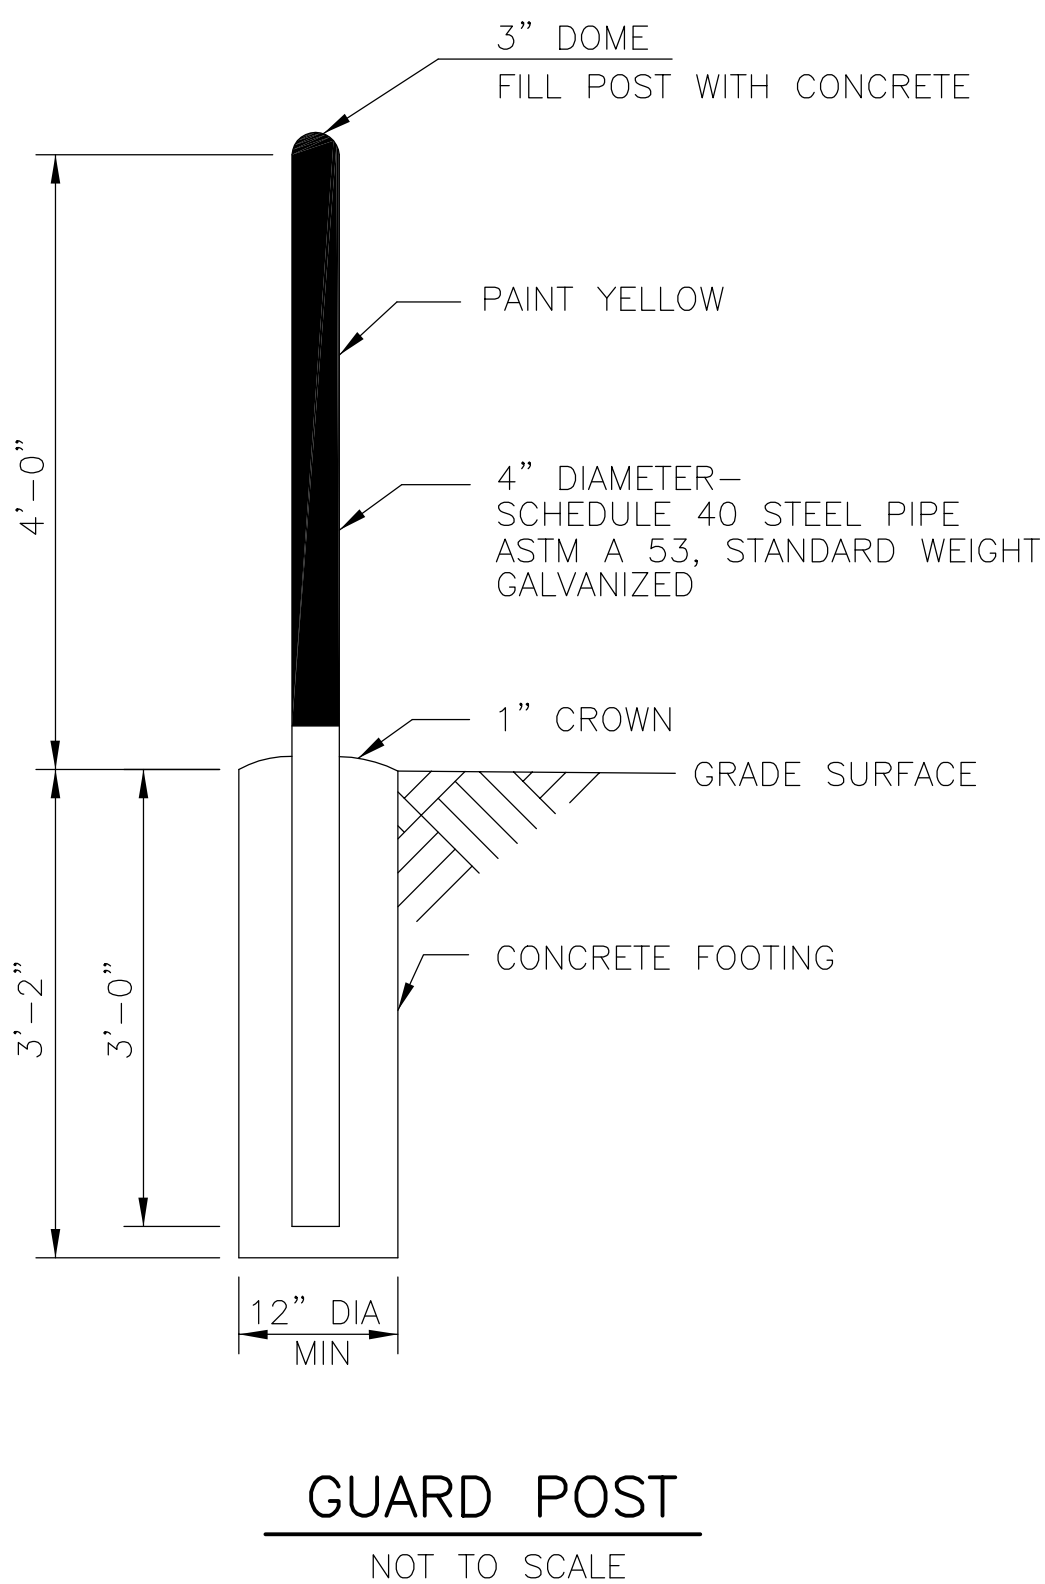


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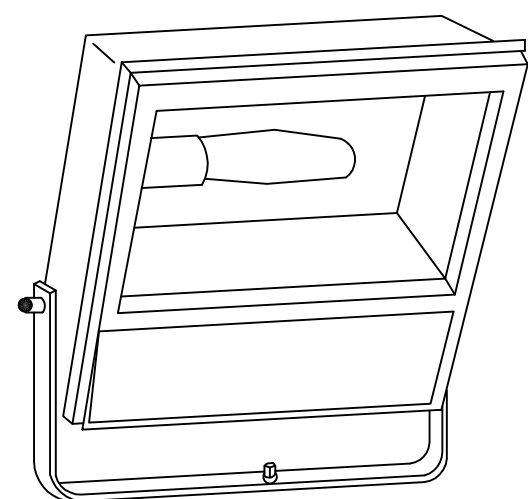


ABBREVIATIONS

- | | |
|-------|-------------------------|
| A | AMPERES |
| C | CONDUIT |
| AFG | ABOVE FINISHED GRADE |
| C | CONDUIT |
| CKT | CIRCUIT |
| EXIST | EXISTING |
| GND | GROUND |
| HH | HANDHOLE |
| HPS | HIGH PRESSURE SODIUM |
| FT | FEET |
| PMT | PAD MOUNTED TRANSFORMER |
| PVC | POLYVINYL CHLORIDE |
| TYP | TYPICAL |
| UON | UNLESS OTHERWISE NOTED |
| V | VOLTS |

LIGHTING FIXTURE SCHEDULE						
FIXTURE SYMBOL	SKETCH NO. & TYPE	NUMBER AND TYPE OF LAMPS	VOLTAGE	MOUNTING	NOTES	
	XL-2	HPS 400 WATTS	480V	XL-22G XL-28C	 1	 2  3  4  5  6

1	LUMINAIRE: COOPER LIGHTING, LUMARK WARRIOR, NEMA BEAM TYPE 6HX5V (HPWR-65S-400-480V)
2	LAMP: SYLVANIA, STANDARD LUMALUX HIGH PRESSURE SODIUM (LU400)
3	POLE: BAYSHORE CONCRETE PRODUCTS CORPORATION, 45FT CENTRIFUGALLY CAST PRESTRESSED CONCRETE
4	SEE PLANS FOR QUANTITY OF FIXTURES
5	PROVIDE XL-34 GROUNDING
6	LUMINAIRE MOUNTING BRACKETS: 2 OF TYPE C



NOTE:
NEMA BEAM SPREAD
CONFIGURATION SHALL BE
AS INDICATED AND SHALL
BE IN ACCORDANCE WITH
I.E.S. DEFINITIONS.


LUMINAIRE REQUIREMENTS

1. HOUSING - DIE CAST ALUMINUM OR FORMED AND SEAM WELDED ALUMINUM, WITH BAKED ENAMEL OR POLYESTER POWDER FINISH.
2. REFLECTOR - ANODIZED ALUMINUM.
3. DOOR - HINGED ALUMINUM, WITH GASKET AND CAPTIVE SCREWS OR CAM LATCH FASTENERS.
4. INTEGRAL MULTI-TAP BALLAST.
5. STAINLESS STEEL OR NONCORROSIVE HARDWARE.
6. PORCELAIN SOCKET WITH VIBRATION-PROOF LAMP GRIP SHELL.
7. SLIPFITTER FOR 2-3/8" TENON OR TRUNNION MOUNTING AS INDICATED.
8. PHOTOCELL WHEN INDICATED.
9. LAMP - 70 TO 1000 WATT - TYPE AND WATTAGE AS INDICATED.
10. PROVIDE 3/C #16 WEATHERPROOF CORD, MIN. 24" LONG (TRUNNION MT. ONLY).
11. LAMP STABILIZER, 1000 WATT SIZE ONLY.
12. LENS - TEMPERED, IMPACT RESISTANT, CLEAR GLASS.
13. UL LISTED - SUITABLE FOR OUTDOOR WET LOCATIONS.
14. HUNGING COLOR SHALL BE DARK BRONZE UNLESS INDICATED OTHERWISE.

MIN. E.P.A. 2.1 SQ. FT. - MAX. E.P.A. 5.5 SQ. FT.


FLOODLIGHT

SKETCH DATE	JUNE 2002	STYLE	XI - 2
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ROUND CONCRETE POLE, DIRECT SET TENON MOUNT

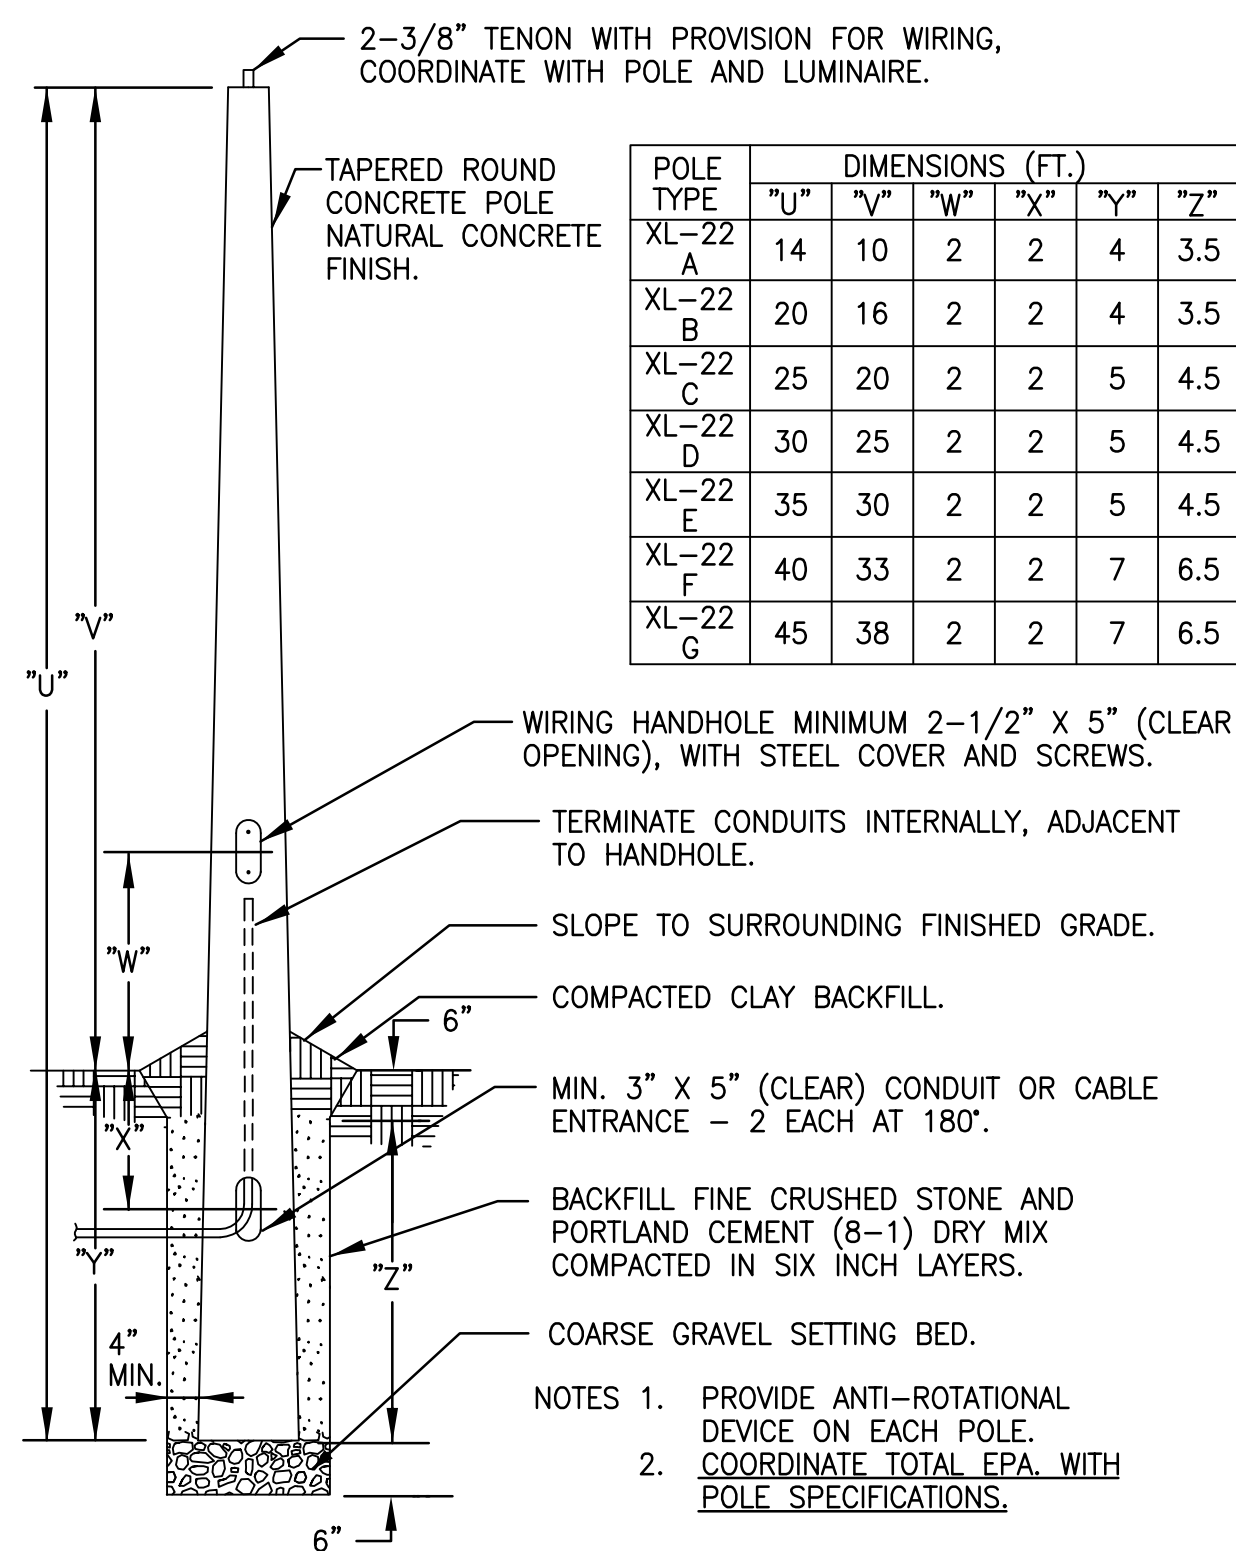
SKETCH DATE	JUNE 2002	STYLE	XI-22
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- NOTES: 1. ALL MATERIALS SHOWN ON THIS SHEET SHALL BE HOT-DIP GALVANIZED.
2. PROVIDE BOLTS AND OTHER HARDWARE AS REQUIRED.

LUMINAIRE MOUNTING BRACKETS

SKETCH DATE	JUNE 2002	STYLE	XI-28
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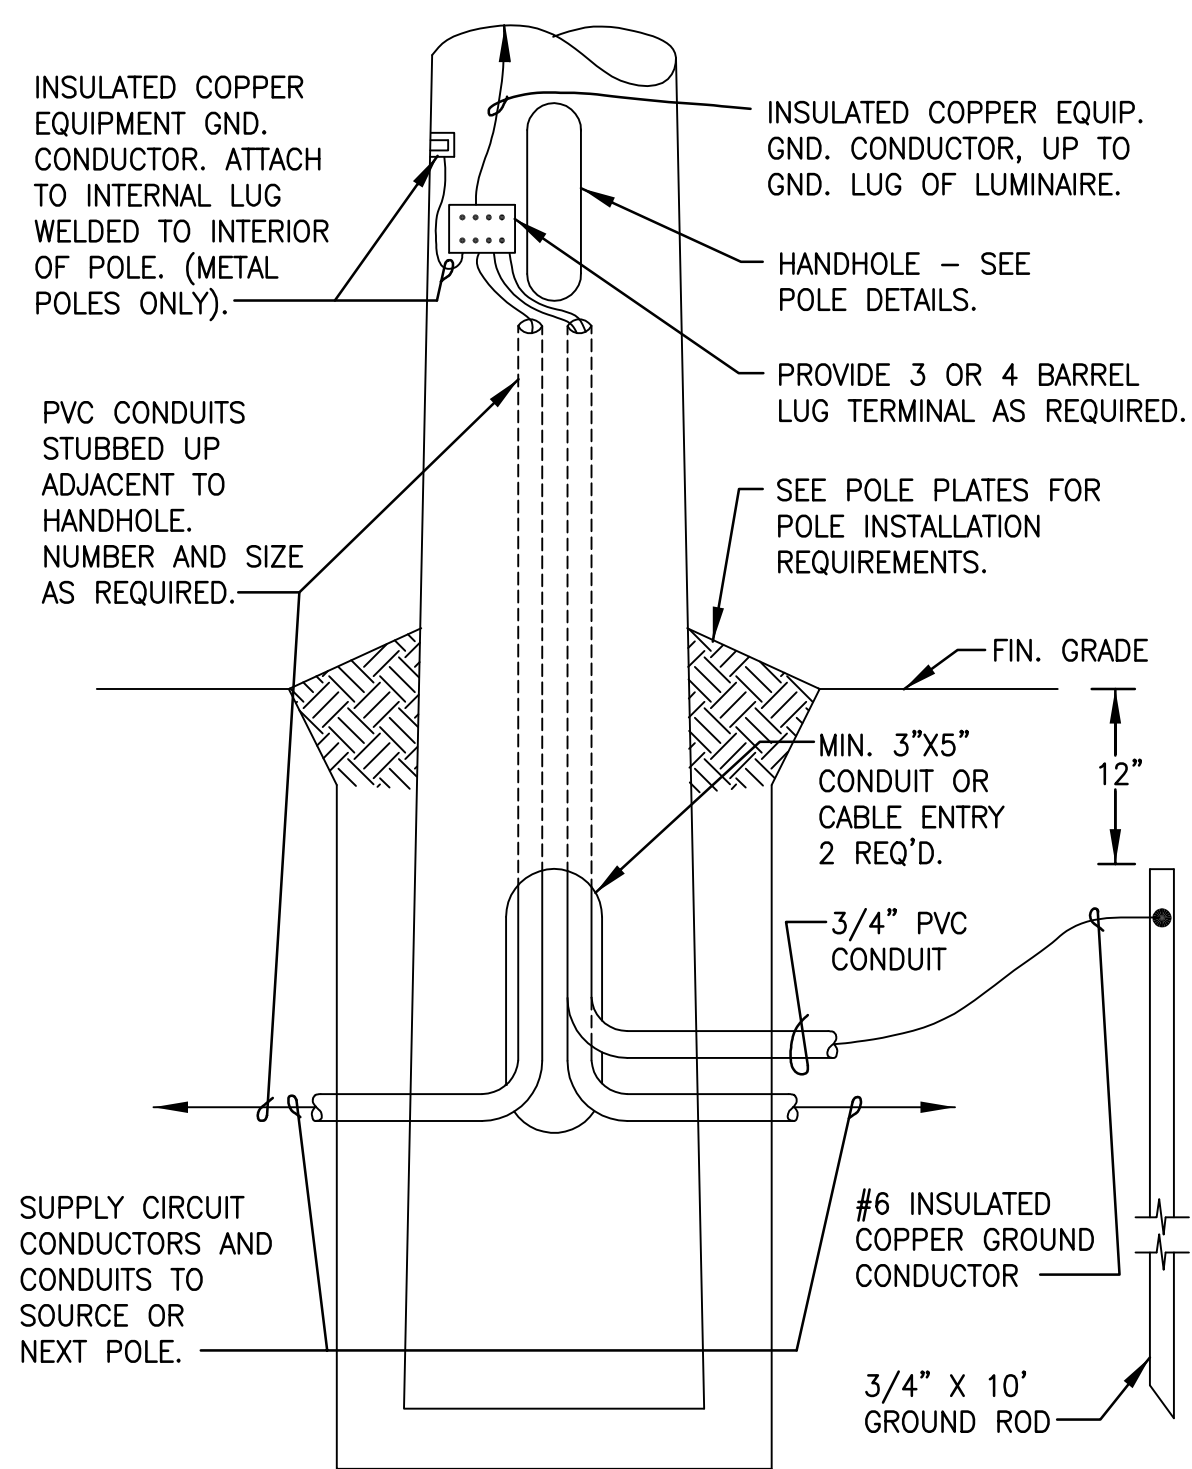


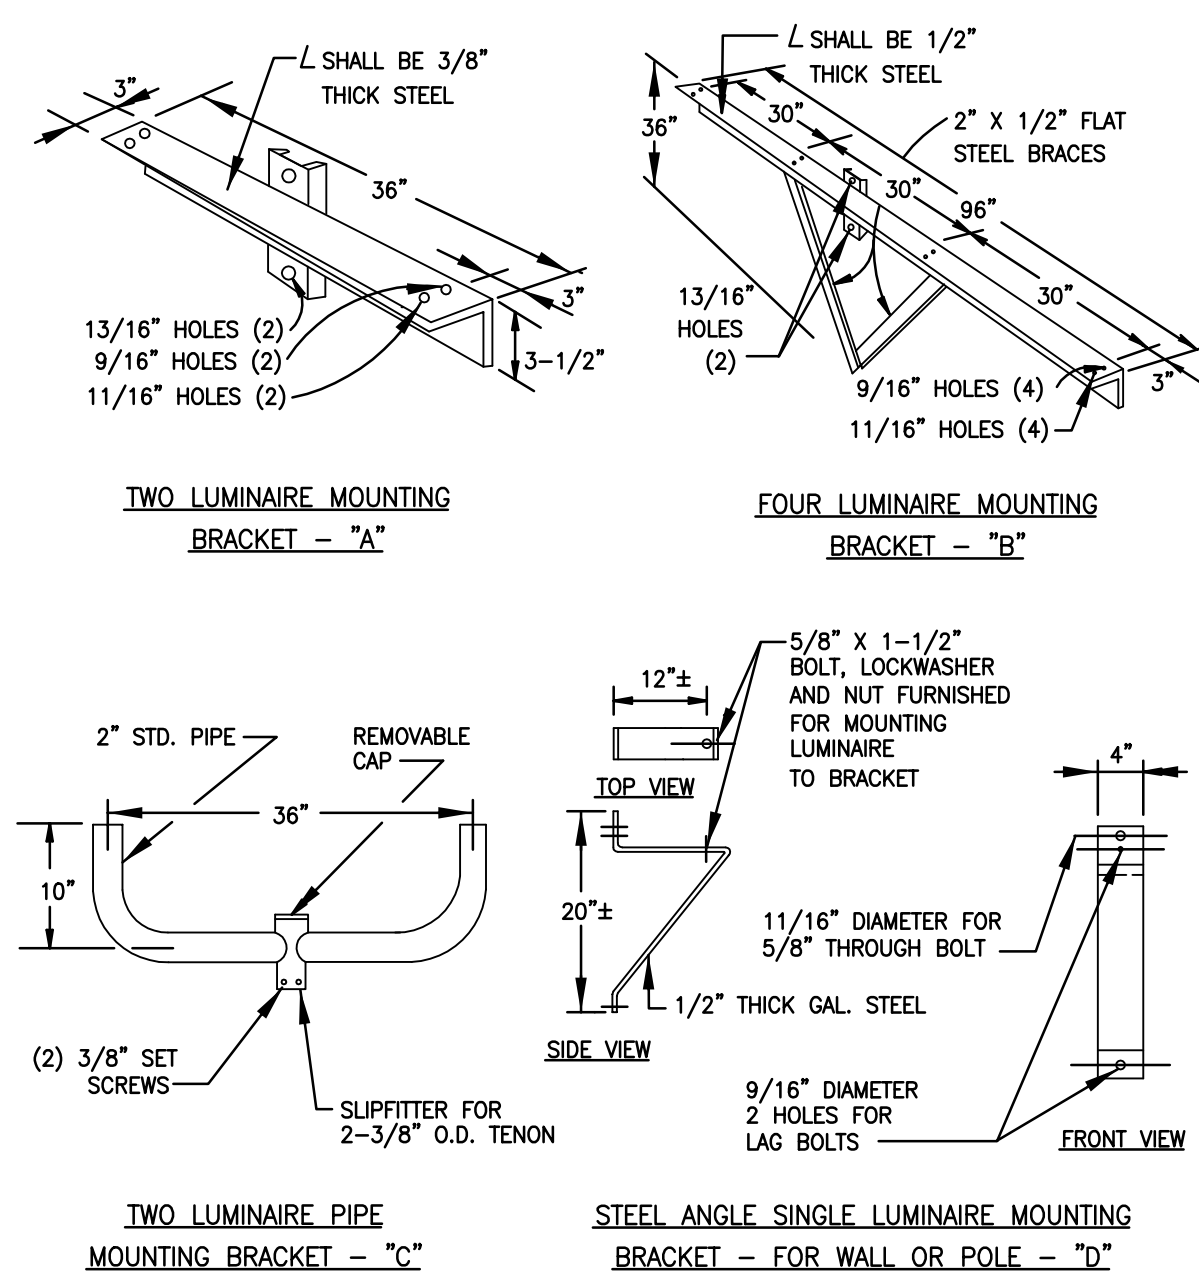HANDHOLE REQUIREMENTS

1. HOUSING SHALL BE A POLYMER CONCRETE REINFORCED WITH A HEAVY WEAVE FIBERGLASS REINFORCING WITH COMPRESSIVE STRENGTH OF NO LESS THAN 10,000 PSI.
2. COVER AND BOX SHALL WITHSTAND A SERVICE LOAD OF NO LESS THAN 15,000 LBS OVER A 10" x 10" AREA.
3. PROVIDE STAINLESS STEEL BOLTS AND INSERTS.
4. PROVIDE WITH (2) 2 1/2" MOUSEHOLES.
5. PROVIDE LABEL "ELECTRICAL" FOR POWER HANDHOLES OR "TELEPHONE" FOR TELEPHONE HANDHOLES, OR AS INDICATED.

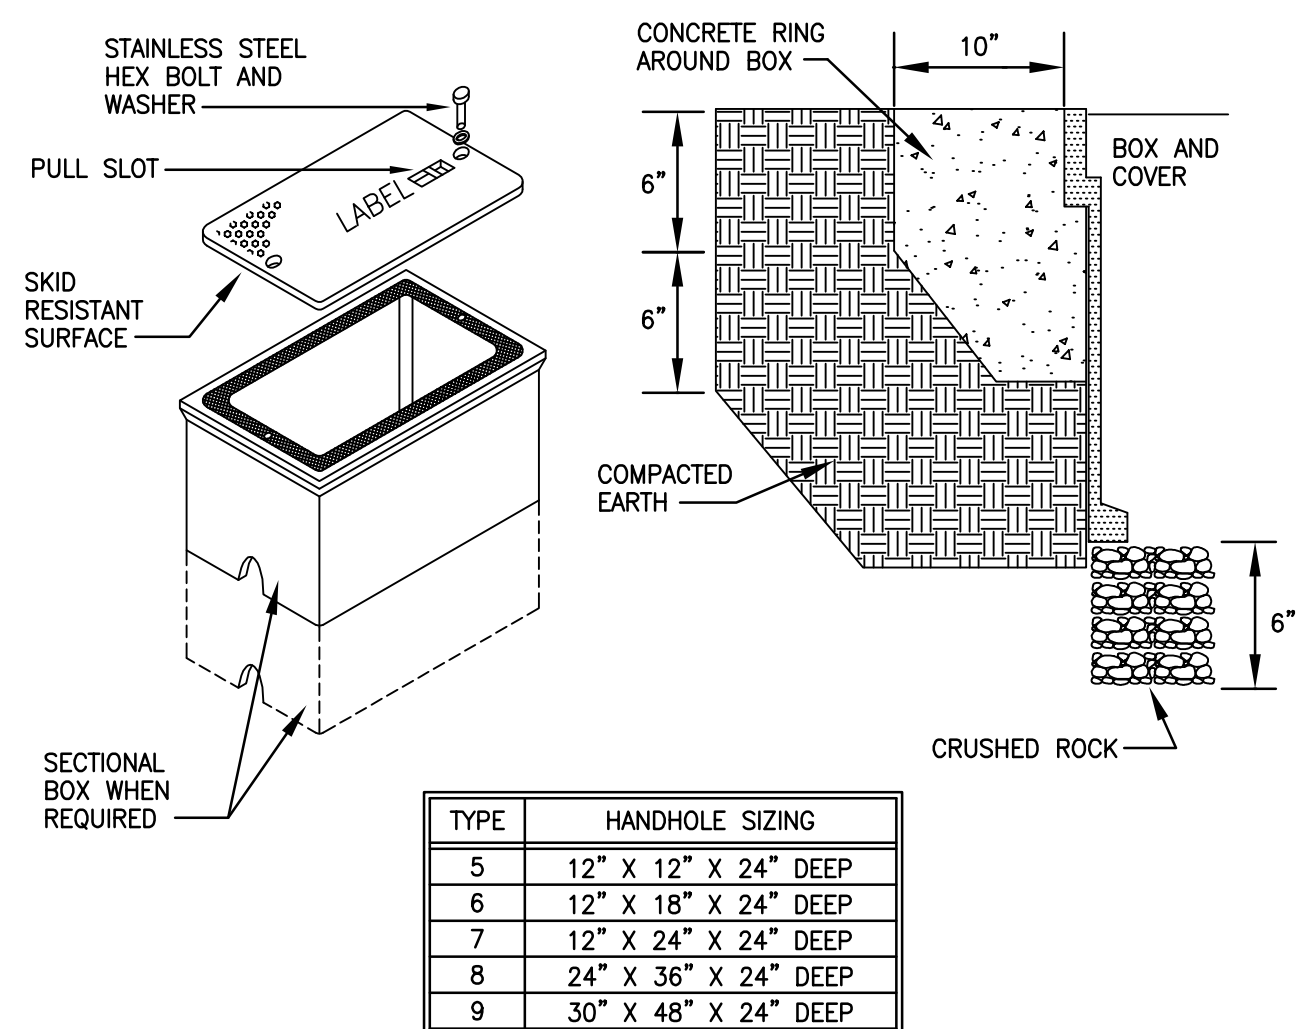STANDARD ELECTRICAL HANDHOLE (NONTRAFFIC)
(COMPOSITE/FIBERGLASS) TYPES 5, 6, 7, 8 & 9

SKETCH DATE	JUNE 2002	STYLE	UG-6
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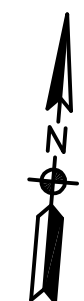


GROUNDING INSTALLATION DETAILS FOR DIRECT SET POLES

SKETCH DATE	JUNE 2002	STYLE	XL-34
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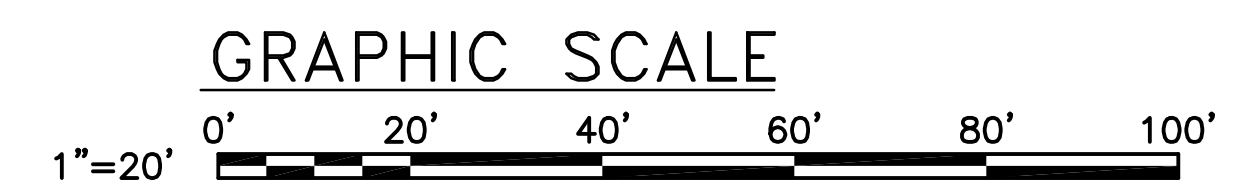
[illegible]

1. THE LIGHTING CIRCUIT IS POWERED FROM AN ENCLOSED 60 AMP, 480V LIGHTING CONTACTOR LOCATED OFF THE SECONDARY OF A 300 KVA TRANSFORMER BEHIND THE OLD AUTO HOBBY SHOP AS SHOWN. CIRCUIT CAN BE DE-ENERGIZED BY OPENING THE 50 AMP CIRCUIT BREAKER. SEE SHEET E-103 FOR LOCATION OF LIGHTING CIRCUIT POWER SOURCE AND CONTROLS.
2. EXISTING WOODEN LIGHT POLES LABELED 620S5, 620S6, 620T6, AND 620U6 ARE CONNECTED OVERHEAD TO A 480V SECONDARY (DUPLEX) CIRCUIT. DISCONNECT EACH EXISTING WOODEN LIGHT POLE FROM THIS CIRCUIT AND REMOVE TAP FROM EXISTING POWER POLE LABELED 620T6A.
3. REMOVE WOODEN LIGHT POLES 620S5, 620S6, 620T6, 620U6; THEIR RESPECTIVE LUMINAIRES, AND ASSOCIATED CIRCUIT CONDUCTORS.
4. AT THE END OF EACH DAY MAKE SURE THE EXISTING LIGHT POLE FEED IS CAPPED OFF AND THE LIGHTING CIRCUIT IS REENERGIZED TO ALLOW FOR NIGHT TIME OPERATION OF REMAINING STREET LIGHT POLES ON THIS CIRCUIT.




ELECTRICAL SITE PLAN


SCALE: 1"=20'-0"

[illegible]

FILENAME: 3A0460E-102.DWG, UPDATED ON 12/16/03 AT 09:19, XREFS: 033A0460BASE, 033A0460PROJ-INFO

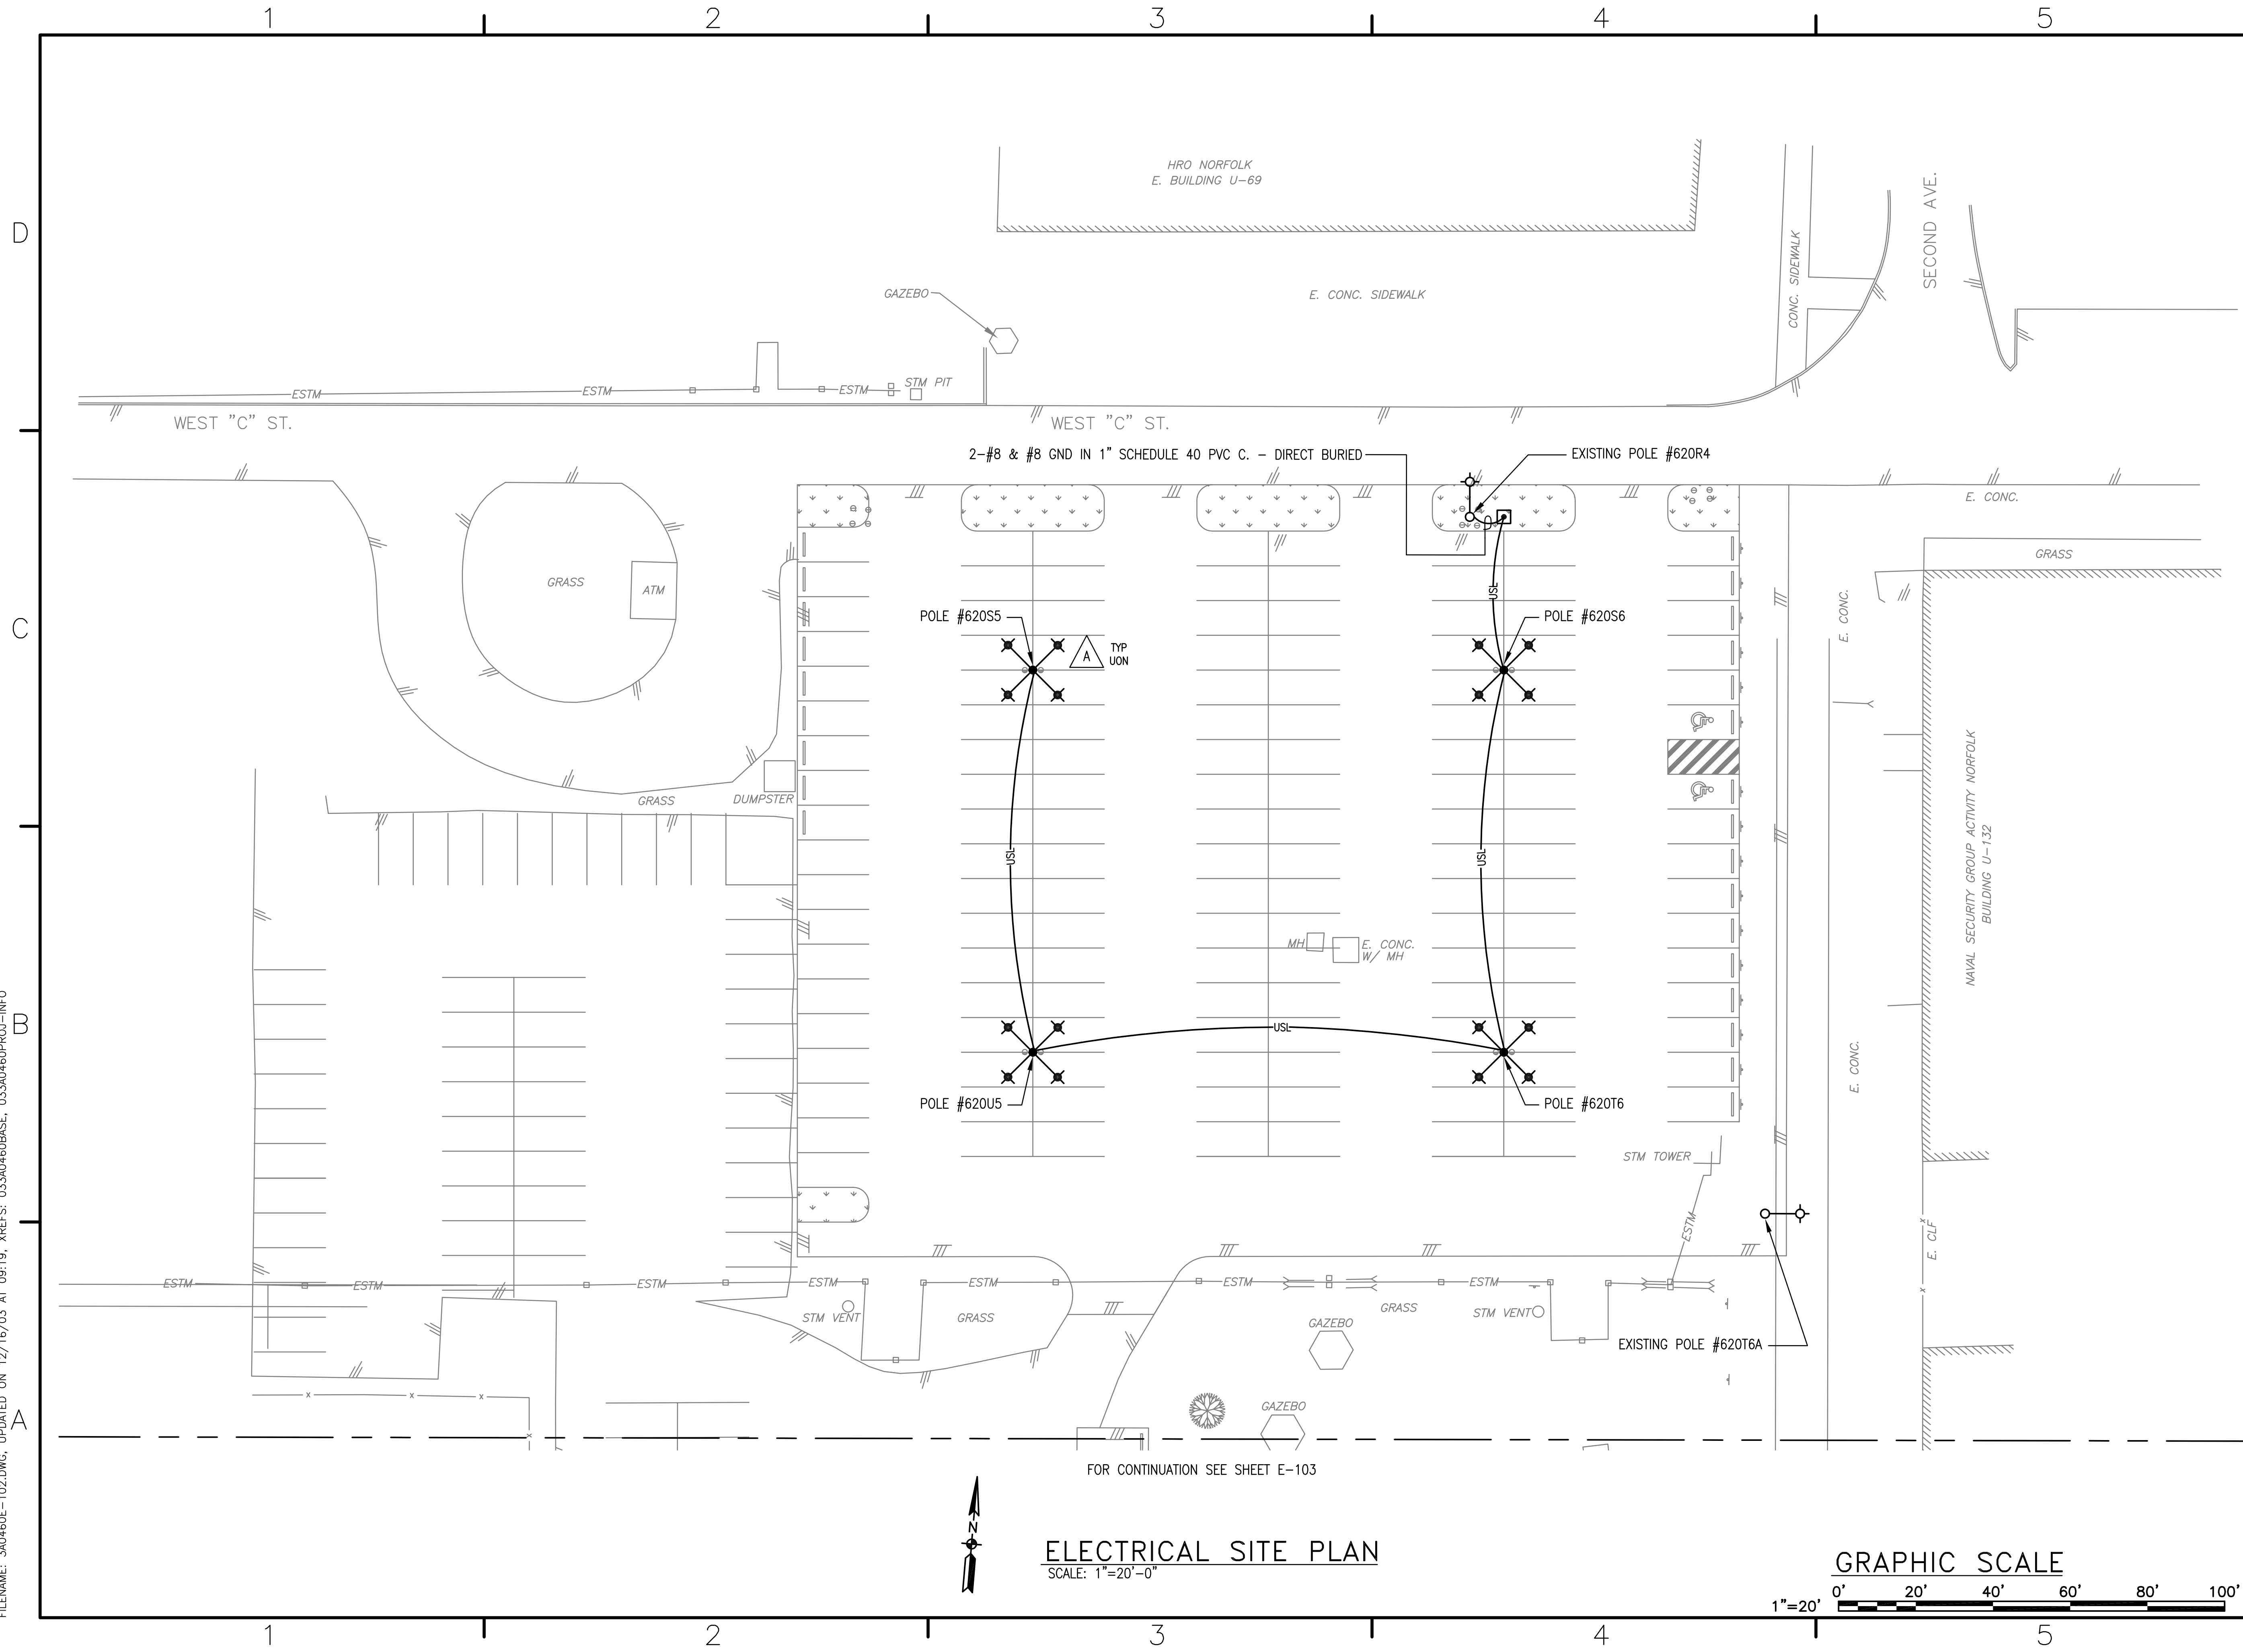


ELECTRICAL SITE PLAN
SCALE: 1"=20'-0"

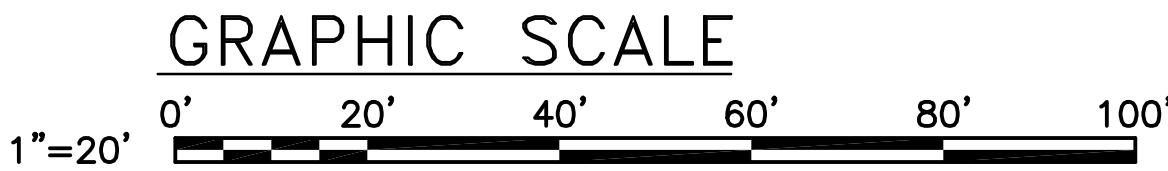

DESIGNED & ENGINEERED BY: LANTDIV NAVAL FACILITIES ENGINEERING COMMAND	DATE 12/17/03	APPROVED J. B. Baven FOR EFD FOR COMMANDER NAVFAC 12/17/03	DATE 12/17/03	A/E DESIGN DRAWN REVIEW QC CHIEF ARCH/ ENGR.	EFD DAM LDS PCH	PROJECT MANAGER FIRE PROTECTION BRANCH MANAGER DESIGN DIRECTOR	NAVAL FACILITIES ENGINEERING COMMAND ATLANTIC DIVISION NAVAL STATION NORFOLK, VIRGINIA NORFOLK, VA	REPAIR PARKING LOT WEST OF BUILDING U-132 ELECTRICAL LIGHTING PLAN	CODE ID. NO. 80091 SCALE: AS NOTED EFD NO. STA. PROJ. NO. R308 SPEC. NO. CONSTR. CONTR. NO. N62470-03-C-3040 NAVFAC DRAWING NO. 4503347 SHEET 15 OF 17 E-102
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FILENAME: 3A0460E-103.DWG, UPDATED ON 12/16/03 AT 08:20, XREFS: 033A0460BASE, 033A0460PROJ-INFO

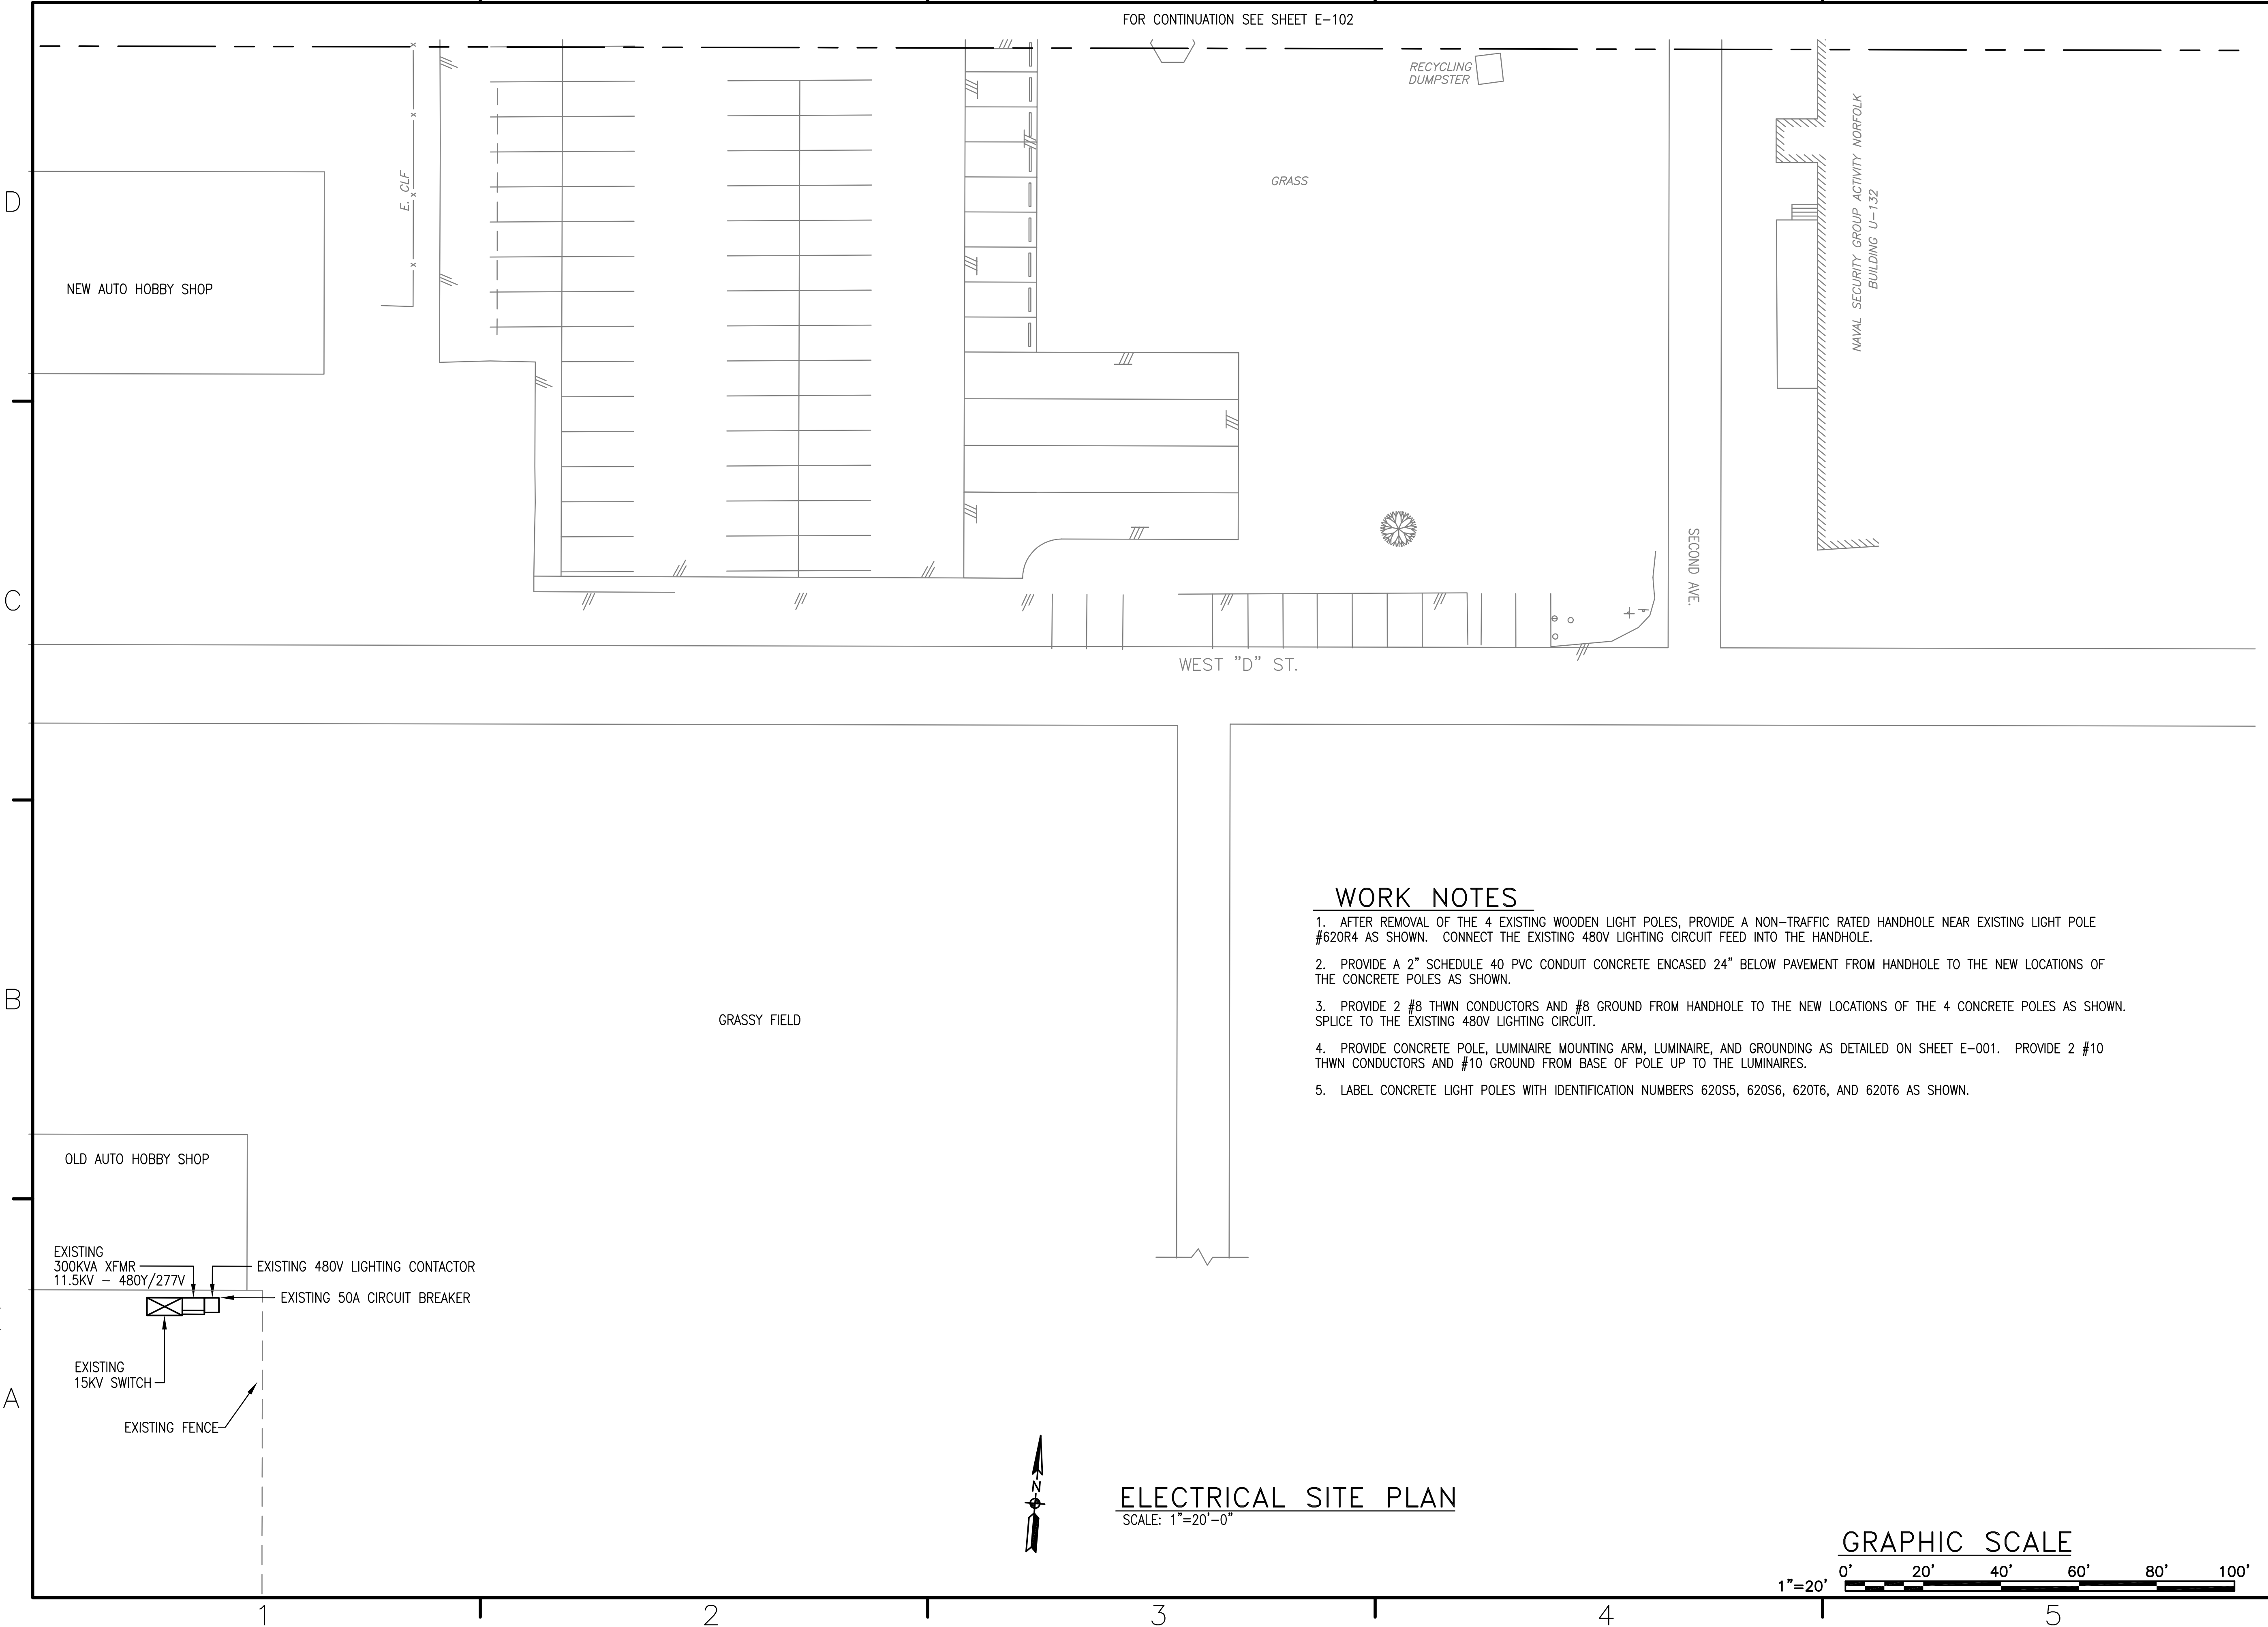


WORK NOTES

1. AFTER REMOVAL OF THE 4 EXISTING WOODEN LIGHT POLES, PROVIDE A NON-TRAFFIC RATED HANDHOLE NEAR EXISTING LIGHT POLE #620R4 AS SHOWN. CONNECT THE EXISTING 480V LIGHTING CIRCUIT FEED INTO THE HANDHOLE.
2. PROVIDE A 2" SCHEDULE 40 PVC CONDUIT ENCASED 24" BELOW PAVEMENT FROM HANDHOLE TO THE NEW LOCATIONS OF THE CONCRETE POLES AS SHOWN.
3. PROVIDE 2 #8 THWN CONDUCTORS AND #8 GROUND FROM HANDHOLE TO THE NEW LOCATIONS OF THE 4 CONCRETE POLES AS SHOWN. SPLICE TO THE EXISTING 480V LIGHTING CIRCUIT.
4. PROVIDE CONCRETE POLE, LUMINAIRE MOUNTING ARM, LUMINAIRE, AND GROUNDING AS DETAILED ON SHEET E-001. PROVIDE 2 #10 THWN CONDUCTORS AND #10 GROUND FROM BASE OF POLE UP TO THE LUMINAIRES.
5. LABEL CONCRETE LIGHT POLES WITH IDENTIFICATION NUMBERS 620S5, 620S6, 620T6, AND 620T6 AS SHOWN.

ELECTRICAL SITE PLAN

SCALE: 1"=20'-0"

GRAPHIC SCALE

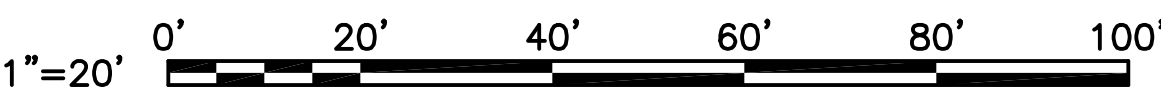

APPROVED	DATE	APPR
ACTIVITY - SATISFACTORY TO		
DATE		
APPROVED		
FOR EFD FOR COMMANDER NAVFAC		
DATE		
A/E	DESIGN	EFD
	DRAWN	LDS
	REVIEW	PCH
	QC	
	CHIEF	ARCH/ ENGR.
PROJECT MANAGER		
FIRE PROTECTION		
BRANCH MANAGER		
DESIGN DIRECTOR		
NAVAL FACILITIES ENGINEERING COMMAND	ATLANTIC DIVISION	NORFOLK, VIRGINIA
NAVAL STATION	NORFOLK	NORFOLK, VA
REPAIR PARKING LOT		
WEST OF BUILDING U-132		
ELECTRICAL LIGHTING PLAN		
CODE ID. NO. 80091	SIZE	D
SCALE: AS NOTED		
EFD NO.		
STA. PROJ. NO. R308		
SPEC. NO.		
CONSTR. CONTR. NO.		
N62470-03-C-3040		
NAVFAC DRAWING NO.		
4503348		
SHEET 16 OF 17		
E-103		
DRAWING REVISION SEPT 2001		

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